
### **GENERAL NOTES**


- 1. BEFORE COMMENCING ANY WORK, THE GENERAL CONTRACTOR SHALL VERIFY ALL THE DRAWINGS, DIMENSIONS, DETAILS, SPECIFICATIONS, & SITE CONDITIONS. NOTIFY THE DESIGNER OF ALL ERRORS, OMISSIONS AND/OR ABNORMALITIES.
- 2. ALL WORK EXECUTED MUST CONFORM TO MUNICIPAL RULES AND REGULATIONS AND NATIONAL BUILDING CODE 2010 C/W MANITOBA BUILDING CODE AMENDMENTS.
- 3. ALL NECESSARY PERMITS MUST BE OBTAINED BY DESIGNER BEFORE STARTING CONSTRUCTION.
- 4. LANDLORD APPROVAL MUST BE AWARDED PRIOR TO START OF INSTALLATION.
- 5. ONE SET OF LANDLORD APPROVED FOR ALTERATION TO BE KEPT ON SITE AND AVAILABLE FOR VERIFICATION AT ALL TIMES OF ALTERATION (IF REQUIRED.)
- 6. ALTERNATE PROPOSALS WILL BE ACCEPTED OR REJECTED BEFORE ISSUANCE OF CONTRACTS.
- 7. COST OF ANY CHANGES REQUIRED BY OTHER TRADES DUE TO SUBSTITUTION OF ALTERNATE MATERIALS SHALL BE INCLUDED IN THE ALTERNATE PROPOSAL.
- 8. G.C. WILL EXAMINE SITE CONDITIONS BEFORE STARTING AND WILL ENSURE THAT NO DAMAGE WILL OCCUR TO UNALTERED PARTS OF THE STORE.
- 9. ALL ITEMS ON DRAWINGS TO BE SUPPLIED & INSTALLED BY CONTRACTOR, UNLESS SPECIFICALLY NOTED OTHERWISE.
- 10. CONTRACTOR TO PROVIDE FIRE EXTINGUISHERS AS PER CODE.
- 11. DO NOT COMPROMISE THE RATING OF ANY DEMISING WALLS.
- 12. DRAWINGS ARE NOT TO BE SCALED. ALL DIMENSIONS SHOULD BE FIELD VERIFIED PRIOR TO SUBMISSION FOR PRICING. IF NOT DESIGNER NO CLIENT IS LIABLE FOR ANY ADDITIONAL COSTS ASSOCIATED WITH ITEM.

Item			I Building Code W/ ndments Data Matr		ling Code			BC Refere ences are to Division Division A or [C] for	n B unless note		
1	Project Descri	ption  □ Change o		w dition eration			■ Part 3				
2	Majar Ossunansı		oi USE II Aite	=			3.1.2.1.(1)				
3	Major Occupancy						1.4.1.2.				
	Building Area (m²						1.4.1.2.				
4	Suite Area		<u> </u>	113.8				24445			
5	Number of Storeys		e - <u>1</u> Below grade - <u>0</u>				3.2.1.1. & 3				
6	Number of Street						3.2.2.10. &				
7 8	Building Classific Sprinkler System		□ selected	uilding compartments floor areas nt □ in lieu of	roof rating		3.2.2.2090 3.2.2.2090 3.2.1.5. 3.2.2.17. INDEX				
9	Standpipe require	ed	□ Yes	■ No			3.2.5.8				
10	Fire Alarm require		□ Yes	■ No			3.2.4.				
11	Water Service/ S			□ No			3.2.5.7. (as	s per existing)			
12	High Building		□ Yes	■ No			3.2.6.				
13	Construction Res		Combustible □ Note permitted □ Note Combustible □ Note Description		3.2.2.2090						
14	Actual Construction  Mezzanine(s) Are			3.2.1.1.(3)	(7)						
15	Occupant load ba	sed on ■	m²/person □ de pancy <u>D</u>	esign of building	persons		3.1.17				
16	Barrier-free Desig	ın 🔳	Yes □ No (Explai	n)			3.8.				
17			• •	,			3.3.1.2.(1) & 3.3.1.20				
18	Hazardous Substances  Yes No  3.3.1.2.(1) & 3.3.1.20  Required Fire RR (Hours) Resistance Rating (FRR)  FRR of Supporting Members  Floors 45 Minutes  Roof N/A Hours  Roof N/A Hours  Floors 45 Minutes  Roof N/A Hours  Roof N/A Hours  Roof N/A Hours  Roof N/A Hours  Floors 45 Minutes  Roof N/A Hours  Roof N/A Hours										
	(Spatial Separation	n - Construction	of Exterior Walls - Co	ntinued)(AS PER E	EXISTING)		3.2.3.				
	Wall Area of EBF(m2	1 1 1	r Max. % of	Proposed % of Openings	FRR (Hours)	Listed Design or Description	Comb Const	Comb. Constr. Nonc. Cladding	Non-comb. Constr.		
	North as per e	xisting design -	'								
	South as per e	xisting design -									
	East as per e	xisting design -									
		xisting design -									
20	Others :		sex universal washrooi	m	, ,		ı				

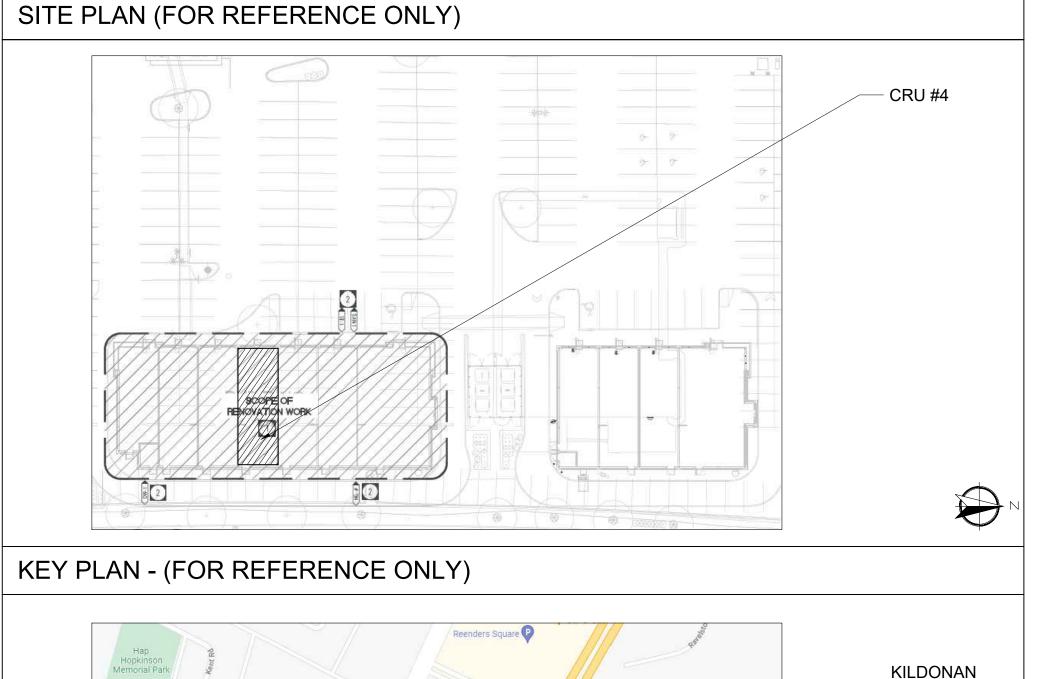

KILDONAN CROSSING 1615 REGENT AVE W WINNIPEG, MB R2C5C6 CRU #4



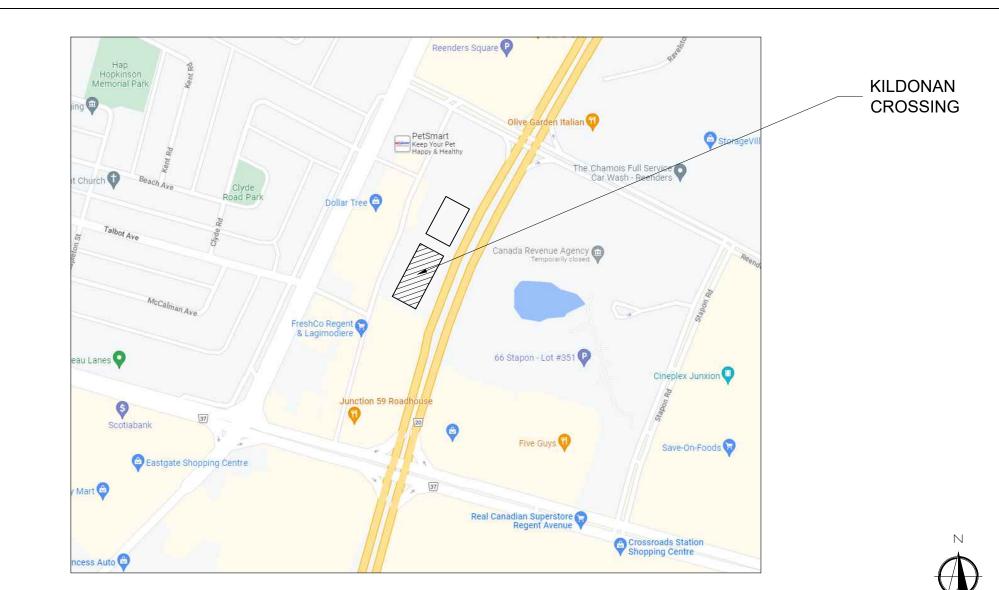

	SY	MBOLS						
SALES AREA	ROOM ID	ENTIFICATION	NTIFICATION ON PLANS					
(D)	DOOR ID	DOOR IDENTIFICATION ON PLANS						
1		WALL TYPE ON ALL PLANS AND ELEVATIONS						
$\langle x \rangle$	FINISHES ON ALL PLANS AND ELEVATIONS							
- XX'-X"	CEILING CEILING	_	ON REFLECTED					
A B	A B	A B	A: DRAWING IDENTIFICATION B: DRAWN ON PAGE					
SECTION EL	EVATION	DETAIL						

	PROJECT DIRECTORY
LANDLORD	
COMPANY:	LS PROPERTIES
CONTACT:	FABRICIO MENDES
ADDRESS:	UNIT 460 - 1615 REGENT AVENUE W. WINNIPEG, MB R2C 5C6
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EMAIL:	fabricio@lsproperties.ca
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COMPANY:	STEEL N INK
CONTACT:	JAMIE RANDOLPH
ADDRESS:	2-330 FIRST ST COLLINGWOOD, ON L9Y 1B4
PHONE:	514-826-2072
EMAIL:	STEELNINK@GMAIL.COM
DESIGNER	
COMPANY:	G.L. SMITH PLANNING & DESIGN
CONTACT:	MELISSA TENPOW
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MECHANICAL/	ELECTRICAL ENGINEER
COMPANY:	G.L. SMITH PLANNING & DESIGN
CONTACT:	BRENT YEE CHING
ADDRESS:	4711 YONGE STREET, SUITE 800 TORONTO, ON M2N 6K8
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EMAIL:	brent@glsmith.ca
GENERAL CO	NTRACTOR
COMPANY:	X
CONTACT:	X
ADDRESS:	X
	X
PHONE:	(XXX) XXX-XXXX
FIIONL.	

	DRAWING INDEX
DWG NO.	TITLE
TP	TITLE PAGE
LS	LIFE SAFETY PLANS
RS	RESPONSIBILITY SCHEDULE
0.0	EXISTING CONDITIONS PLAN
1.0	STOREFRONT PLAN & ELEVATION
2.0	CONSTRUCTION PLANS
2.1	RESTROOM DETAILS
3.0	INTERIOR ELEVATIONS
3.1	MILLWORK DETAILS
4.0	REFLECTED CEILING + COMMUNICATIONS PLANS
5.0	FINISHES PLANS
M1.0	DRAWING LIST AND MECHANICAL LEGENDS
M2.0	DETAILS
M3.0	PLUMBING PLAN AND NOTES
M3.1	SANITARY PLAN AND NOTES
M4.0	HVAC PLAN AND NOTES
M5.0	SCHEDULES
M6.0	SEPCIFICATIONS
M6.1	SEPCIFICATIONS
M6.2	SEPCIFICATIONS
E1.0	DRAWING LISTS AND ELECTRICAL LEGENDS
E1.1	ELECTRICAL DETAILS & SINGLE LINE DIAGRAM
E2.0	LIGHTING PLAN
E3.0	POWER SYSTEMS, PLAN & RISER PANEL SCHEDULE
E4.0	ELECTRICAL DETAILS
E5.0	ELECTRICAL SPECIFICATIONS



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 APRIL 25, 2023
 ISSUED FOR CLIENT REVIEW
 BS

 #
 Date
 Description
 Dw

PROJECT TITLE:

REVISION

STEEL N INK

KILDONAN CROSSING 1615 REGENT AVE W WINNIPEG, MB R2C 5C6 CRU # 4

# Date Description Dw
DRAWING TITLE:

TITLE PAGE

PRINT DATE:

17-May-23

DRAWN BY:

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MT


SCALE:

N/A

DRAWING NO:

TP

PROJECT NO:

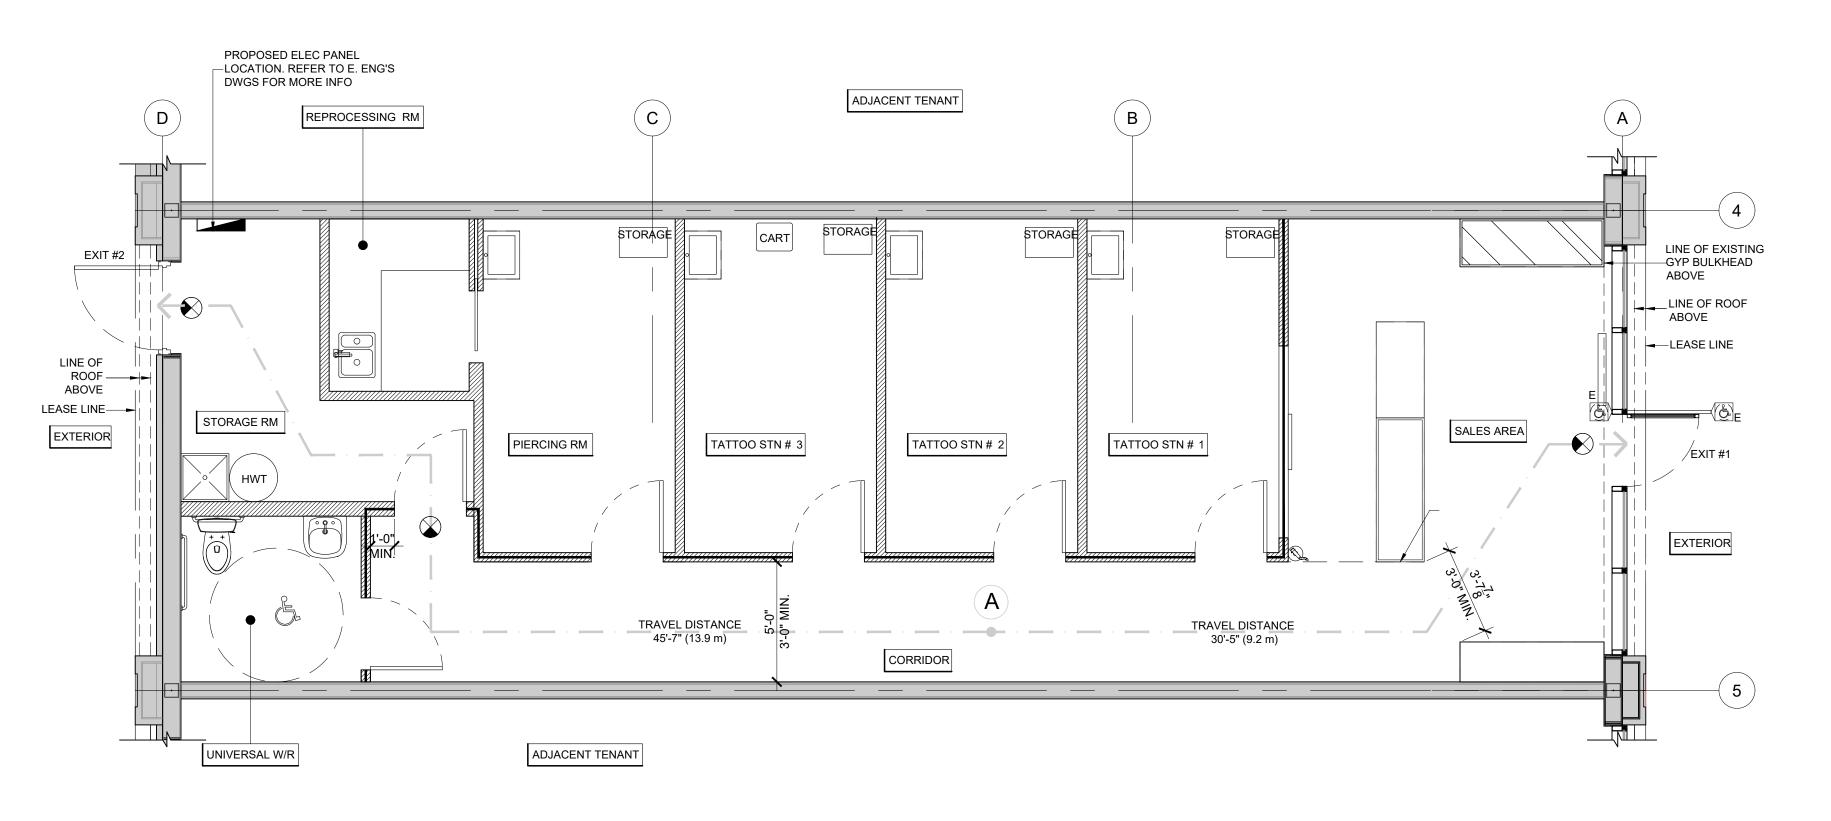

A LIFE SAFETY PLAN LS SCALE: 1/4"=1'-0"

PLUMBING FACILITIES	LEGEND		EXIT ACCESS TRAVEL DISTANCE			AREA CALCULATIONS		EGRESS CALC	ULATIONS		OCCUPANCY LOAD CALCULATIONS					
OTAL OCCUPANCY LOAD: 26 PERSONS	SYMBOL	DESCRIPTION	PER NATIONAL BUILDING CODE 2010 C/W MANITOBA BUILDING CODE AMENDMENTS. (OCCUPANCY - 'D' PERSONAL SERVICES )			RETAIL / HALLWAY	523 SQ FT.		EGRESS WIDTH PER OCCUPANT SERVED FOR USER GROUP-D (PERSONAL SERVICES) AS PER SECTION 3.4.3.2.(1).(a). CAPACITY OF ACCESS TO EXITS - NATIONAL BUILDING CODE							
FEMALES + 13 MALES = 26 PERSONS AS PER SENTENCE 3.7.2.2.(1)		HATCHED AREA OF NO WORK	REMOTE POINT	MAXIMUM ALLOWABLE TRAVEL DISTANCE	TRAVEL DISTANCE TO EXIT 1	TRAVEL DISTANCE TO EXIT 2	REPROCESSING ROOM	49 SQ FT.			NDMENT - 6.1mm EGRESS					
ATER CLOSETS REQUIRED FOR EACH SEX: (1) AS PER TABLE 3.7.2.2.B.		DENOTES TRAVEL DISTANCE	A	30m PER NBC 2010 3.4.2.5.(1)(F)	30'-5" (9.2 m)	45'-7" (13.9m)	WASHROOMS	64 SQ FT.	OCCUPANT LOAD	EGRESS WIDTH REQUIRED	EGRESS WIDTH PROVIDED	NO. OF EXITS REQUIRED	OCCUPANCY LOAD CALCULATIONS			
TER CLOSETS PROVIDED: (1) NEW UNISEX UNIVERSAL WASHROOM  /ATORIES REQUIRED: (1) FOR A ROOM CONTAINING ONE OR TWO		FIREPULL					STORAGE AREAS	119 SQ FT.	25 OCCUPANTS	6" (152.5 MM) MINIMUM	7.5" (193 MM)	(2) EXITS				
WATER CLOSETS AS PER 3.7.2.3.		FIRE EXTINGUISHER					TATOO STN	333 SQ FT.	EGRESS REQU	JIRED			TOTAL APEA : 113 8 SO M (1225 SO ET )	= 25 PEOPL		
ATORIES PROVIDED: (1) PROVIDED	<b>(</b>	EXIT SIGN	(IT SIGN						PIERCING ROOM	111 SQ FT.	NUMBER OF EXITS REQUIRED: 2 NUMBER OF EXITS PROVIDED: 2				TOTAL AREA: 113.8 SQ M.(1225 SQ FT.) = /4.6 SQ M.(49.5 SQ FT.)	- 23 FEOFL
CALCULATED REQUIRED NUMBER OF PLUMBING FIXTURES AS PER NATIONAL BUILDING CODE 2010 C/W MANITOBA BUILDING CODE AMENDMENTS:	(£)	PUSH BUTTON ACTUATOR	NOTE: PORTABLE FIRE	E EXTINGUISHERS SHALL BE PROVIDED AND IN	NSTALLED IN ACCORDANC	E WITH PROVINCIAL OR	TOTAL AREA	1225 SQ FT.	DOORWAY WIDTH: DOOR WIDTH: EGRESS PASSAGE		800 mm MIN. 800 mm MIN. 1100 mm MIN.					
REFERENCES 3.7.2.2.(1), 3.7.2.2.B., 3.7.2.3.		T EMERGENCY LIGHTING & EXIT SIGNS R TO SHEETS 4.0 & ELECTRICAL DWGS.	TERRITORIAL REGULATIONS OR MUNICIPAL BYLAWS. LOCATIONS TO BE MARKED WITH RED AND WHITE SIGN ABOVE (CONTAINING SYMBOL OR PHRASE. FIRE EXTINGUISHERS SHOULD BE PROVIDED WITH CURRENT CERTIFICATION TAGS BY A LICENSED INSPECTION SERVICE AT TIME OF TURNOVER.			TOTAL AILEA 1225 SQ F		•		PRINKLERED) PER NATIONAL BUILDING CODE		TOTAL OCCUPANT LOAD :	= 25 PEOP			



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2.	MAY 4, 2023	ISSUED FOR L.LORD REVIEW	MT
1.	APRIL 25, 2023	ISSUED FOR CLIENT REVIEW	BS

Date Description

REVISION

DRAWING TITLE:

STEEL  $\mathbb{N}$ INK

KILDONAN CROSSING 1615 REGENT AVE W WINNIPEG, MB R2C 5C6 CRU # 4

#	Date	Description	Dwn

LIFE SAFETY PLAN

PRINT DATE:	SCALE:
17-May-23	AS NOTED
DRAWN BY: BS	DRAWING NO:
CHECKED BY:	LS
PROJECT NO: 23-1020	

# RESPONSIBILITY SCHEDULE

RESPON	LANDLO	RD O	WNER	GENE	ANT'S ERAL ACTOR		RESPONS	LANDLORD	OWNER	R	TENANT'S GENERAL ONTRACTOR	3	RESPONS LA	NDLOF	RD C	OWNER	R GE	ENANT'S ENERAL ITRACTOR	
RESPONSIBLE MATERIAL		NSTALL SUPPLY	NSTALL	UPPLY	NSTALL	REMARKS	RESPONSIBLE MATERIAL	UPPLY	UPPLY	ISTALL	UPPLY	REMARKS	RESPONSIBLE SIGN		ISTALL UPPLY	: - : - : - : -	ISTALL UPPLY	ISTALL	REMARKS
L.LORD APPROVAL	0)	<u> </u>	=	S		/ G.L. SMITH PLANNING &	JUNCTION BOX AT CASH WRAP	<i>σ</i> <u>∠</u>	<u> </u>	<u> </u>	<ul><li>ω ≥</li><li></li></ul>		CASH WRAP	<u> </u>	<u> </u>	) <u>4</u>	<u>≤</u>		G.C TO USE REQUIRED VENDOR.
PERMITS AND FEES					В	G.L. SMITH PLANNING &	CASH REGISTER EQUIPMENT		•				DISPLAY UNIT				•		G.C TO USE REQUIRED VENDOR. COORDINATE W/ CLIENT
HOARDING						C. TO CONFIRM BASED ON PECIFIC SITE	WIRING/CABLING IN CASH WRAP				• •		TATTOO CHAIR		•				
HOARDING GRAPHICS		•		•		INDOW COVERINGS PROVIDED BY C. GRAPHICS BY CLIENT	TELEPHONE DISTRIBUTION/ WIRING		•		• •	COORD W/ VENDOR. PHONE LINE BY CLIENT, CONDUIT BY CONTRACTOR	TATTOO EQUIP		•				
_							ELECTRIC CONDUIT				• •		6' JEWELRY DISPLAY					•	G.C TO USE REQUIRED VENDOR. COORDINATE W/ CLIENT
DEMOLITION- STOREFRONT					N	/ A	DISPLAY, DECORATIVE & GENERAL LIGHT				• •	· ·	ဟု IPAD BAR				•	•	BY G.C. MILLWORK VENDOR
DEMOLITION- INTERIOR PARTITIONS					N	/ A	FIXTURES & BULBS						DIGITAL DISPLAY						G.C. TO COORDINATE W/ CLIENT
DEMOLITION- CEILINGS					N	/ A	BOH LIGHT FIXTURES & BULBS				•		SINK + CABINETS						G.C. TO COORDINATE W/ CLIENT
DEMOLITION- WASHROOMS					N	/ A	ELECTRICAL PANEL & SERVICE	•			• •		BACKSPLASH				•		G.C. TO COORDINATE W/ CLIENT
DEMOLITION- DEMISING WALLS					N	/ A	ALARM SYSTEM					N/A	ELEC PANEL COVER						N/A
REMOVE EXIST. FF&E AND FINISHES					N	/ A	SPEAKER SYSTEM					G.C TO COORDINATE W/ CLIENT	STORAGE CABINETS						}
REMOVE & CAP EXIST. PLUMBING & ELEC.					N	/ A	EMERGENCY LIGHTING				• •								
EXISTING CONCRETE SLAB	•					C. TO LEVEL AND REPAIR AS EQUIRED.	OUTLETS				• •								
TEMPORARY FACILITIES, SERVICES & CONTROLS							TIME CLOCK				• •								
CLEAN UP					•		SWITCHES				• •								
BLOCKING				•	•		SENSORS				• •	<u> </u>	I.T. CABINET						N/A
DEMISING WALL STUDS					N/	A							COMPUTERS & COMPUTER SYSTEM						N/A
DEMISING WALL GYPSUM BOARD					M	C TO PATCH & REPAIR AS REQ'D. AINTAIN FIRE RATING IN ALL PPLICABLE AREAS	EXHAUST FANS/ VENTS WASHROOM				•		Ŏ J					ļ	
STRUCTURAL STEEL					N	/ A	FIRE DETECTION				• •		STOREFRONT SIGN				•	•	
SEISMIC REQUIREMENT					N	/ A	FIRE EXTINGUISHERS				• •		BLADE SIGN						N/A
INTERIOR PARTITIONS					•		HVAC UNIT				• •		INTERIOR SIGNAGE, GRAPHICS				•		
GYPSUM BOARD CEILING/FIRE RATING					N	/ A	HVAC CONTROL (THERMOSTAT)				• •	MODIFY AS REQ'D	"NEON" SIGN						SIGNAGE TO BE PROVIDED BY CLIEF MOUNTING BY G.C. (PLUG IN POWER
ACOUSTIC CEILING TILE /GRID					•		DUCTWORK				• •		INTERIOR FIXTURE SIGNAGE				•	•	
FURRING STRIPS					•		SPRINKLERS					N/A	WASHROOM SIGNAGE				•	•	
INTERIOR DOORS/ FRAMES							AIR CURTAINS					N/A	ADVISING ENGINEERS/DESIGNER OF FINAL INSPECTIONS				•		G.C. MUST GIVE DESIGNERS/ ENGINEERS 2 WEEKS NOTICE
REAR EXIT DOORS/ FRAMES					E	VISTING TO REMAIN. G.C TO USURE IN GOOD WORKING	SERVICE ACCESS/ ACCESS PANELS				• •								
						ONDITION. REVIEW ANY ISSUES W/	NEW AIR FILTERS AT STORE TURN-OVER				• •		MISO OS OS OS OS OS OS OS OS OS OS OS OS O						
DOOR HARDWARE					DO	OOR LOCKS (CORES) BY CLIENT	WASHROOM SINKS				• •							_	
STOREFRONT DOORS					E	VISTING TO REMAIN. G.C TO USURE IN GOOD WORKING	TOILETS				• •								
STOREFRONT GLAZING					DI	ONDITION. REVIEW ANY ISSUES W/	HOT WATER TANK				• •		COMPANY/SUPPLIER CO	NTACT	NAME		PHONE	E NUMBER	RESPONSIBLE FOR
TELEPHONE & ELEC. BACK BOARDS						RE RATED PLYWOOD. REFER TO ECTRICAL DWGS.	BARRIER FREE HARDWARE				• •		OLYMPIA TILE DE	EANNA	MALONE	ΞΥ	416 78	85 9555 X 3	ALL FLOORING
STOCKROOM- FLOORING FINISH							KITCHEN PLUMBING FIXTURE PACKAGE					N/A	0,2	ERRY K	OOIMAN		jerry@	)kooiman.ca	a MILLWORK
SALES AREA - FLOORING FINISH							WATER FILTER					N/A	TBD						STOCK SHELVING
BATHROOM - FLOORING FINISH							SANITARY WASTE AND VENT				• •	EXISTING UNUSED PLUMBING LINES TO BE CLEANED UP.	O TBD						IT
SCHLUTER STRIPS					• s	EE DWG 2.1/5.0 FOR DETAILS	PORTABLE WATER SUPPLY					N/A	TBD						LIGHTING
BASE THROUGHOUT							FLOOR DRAINS				• •		NOTE: THIS CHART IS PROVIDED AS A GUIDE A INDICATING RESPONSIBILITIES, PLEASE						
PAINT													INDICATING RESPONSIBILITIES. PLEASE THE REPONSIBILITY OF THE CONTRACT DOING SO DOES NOT EXEMPT THE CON	TOR OF	R SUB TF	RADE T	O CONTA	ACT GLS IN	MMEDIATELY FOR CLARIFICATION. N
WALL FINISHES													PROVIDING A PRODUCT OR PROFORMA						



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1220E			

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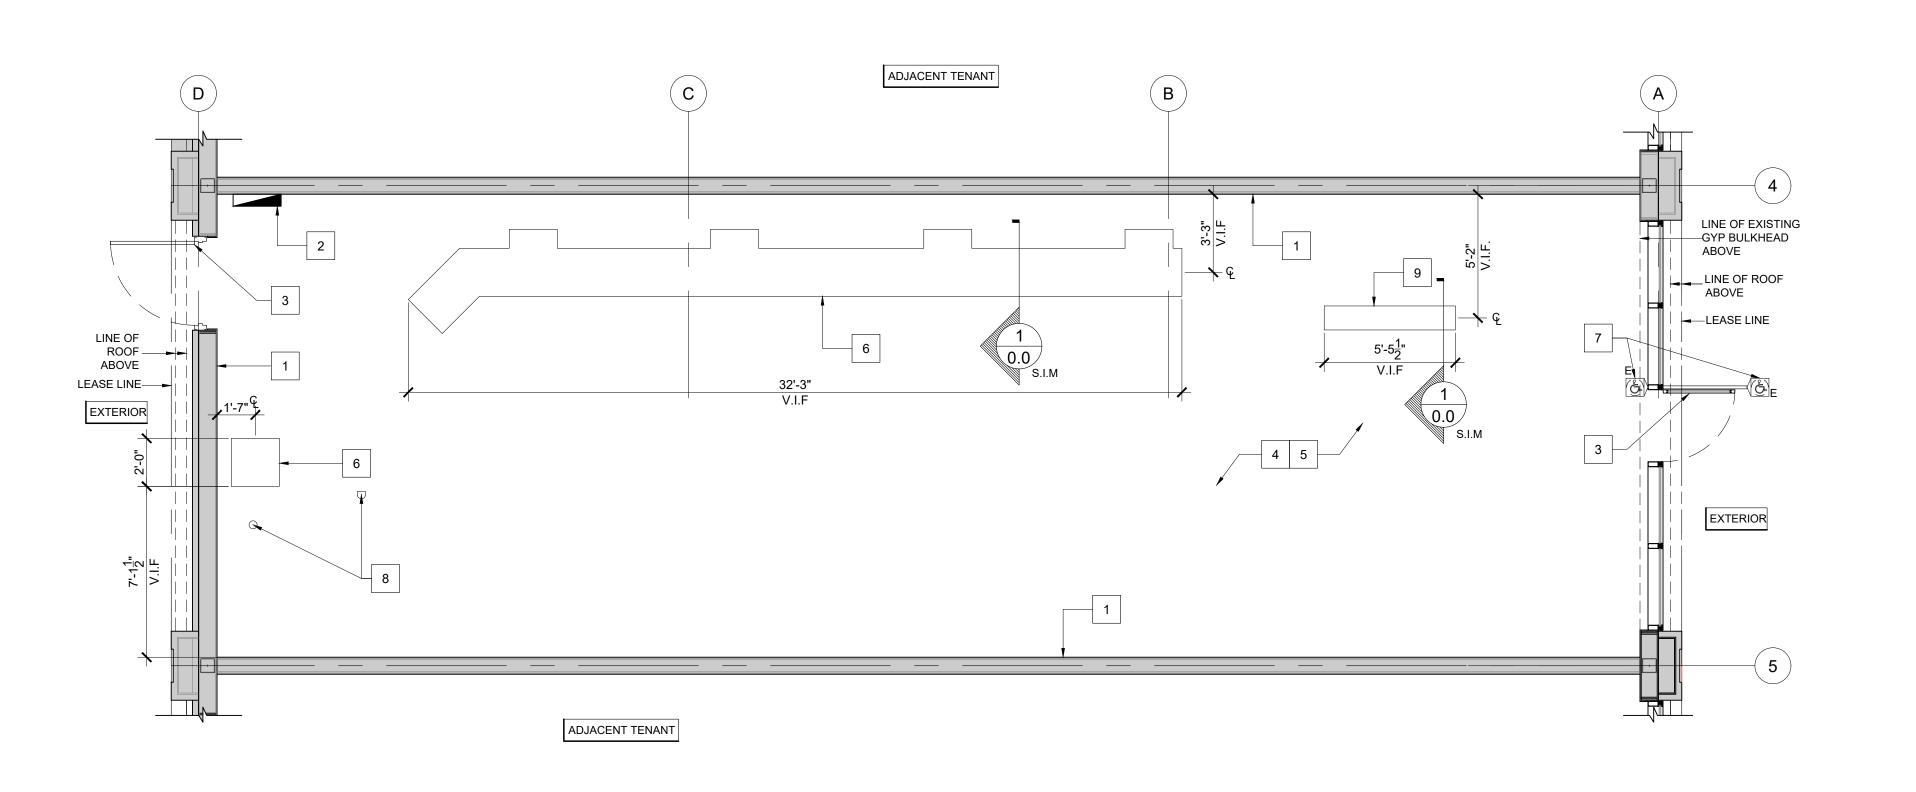
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KILDONAN CROSSING 1615 REGENT AVE W WINNIPEG, MB R2C 5C6 CRU # 4

1	MAY 17, 2023	REV TO RESPONSIBILITY SCHEDULE	BS
#	Date	Description	Dwn
-	Date	Becompaier	D W

RESPONSIBILITY SCHEDULE

PRINT DATE:	SCALE:
17-May-23	N/A
DRAWN BY:	DRAWING NO:
BS	
CHECKED BV:	<b>—</b> •





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ISSUE

4. MAY 18, 2023 ISSUED FOR TENDER BS
3. MAY 17, 2023 ISSUED FOR PERMIT BS

MAY 4, 2023 ISSUED FOR L.LORD REVIEW
 APRIL 25, 2023 ISSUED FOR CLIENT REVIEW

EXISTING POWER DOOR OPERATOR TO REMAIN. G.C TO ENSURE IN GOOD WORKING ORDER

EXISTING DEMISING WALL TO REMAIN & PATCH/REPAIR AS REQ'D, G.C. TO REVIEW L.L. WORK AND ADVISE CLIENT OF ANY ISSUES.

PROPOSED LOCATION OF NEW ELECTRICAL PANELS. COORDINATE

G.C TO CONFIRM OVERALL UNIT DIMENSIONS. REPORT FINDINGS TO

G.C TO SALVAGE ANY EXISTING GREEN RUNNING MAN EXIT SIGNS

APPROX. LOCATION OF TRENCHING FOR NEW SANITARY LINES.

3 EXISTING DOOR TO REMAIN - COORDINATE W/ DOOR LEGEND

**KEYED NOTES:** 

W/ ENG DWGS

4 CLIENT AND DESIGNER TO REVIEW

| 5 | WHICH CAN BE REUSED IN NEW DESIGN

REFER TO MECH ENG'S DWG'S FOR MORE INFO.

8 EXISTING PLUMBING ROUGH INS BY LANDLORD. VERIFY LOCATION IN FIELD.

APPROX. LOCATION OF TRENCHING FOR CASH CONDUITS. REFER

TO DWG 4.0 AND ELEC ENG DWGS FOR MORE INFORMATION

# Date Description

PROJECT TITLE:

 $\mathbb{N}$ 

INK

KILDONAN CROSSING 1615 REGENT AVE W WINNIPEG, MB

R2C 5C6

CRU # 4

REVISION

# Date Description Dv

EXISTING CONDITIONS PLAN

PRINT DATE:

17-May-23

DRAWN BY:

BS

CHECKED BY:

SCALE:

AS NOTED

DRAWING NO:


PROJECT NO:
23-1020

DRAWING TITLE:


REFILL TOP OF TRENCH WITH MAPEI REPAIR VAPOR BARRIER MAPECEM PREMIX OR MAPECEM AS REQ'D (IF EXISTS) QUICKPATCH (2" MAX. THICKNESS) G.C. TO USE COMMON PRACTICE TO IN FILL TRENCH EXISTING SLAB 20M DOWELS @ 18" C/C DRILLED AND GROUTED INTO EXISTING FLOOR SLAB. MIN. 6" REFILL TRENCH WITH CONCRETE CUT EXISTING SLAB AND PLACE COMPACTED TYPE 1 FILL IN TRENCH TO U/S OF NEW SLAB. PLACE 6 MIL POLY VAPOR BARRIER NEW SANI LINE OR CONDUIT UNDER SLAB, LAP AND SEAL WITH EXISTING VAPOR BARRIER. SLAB THICKNESS TO MATCH EXISTING. 1 TRENCHING DETAIL 0.0 SCALE: 1 1/2"=1'-0"

A DEMOLITION PLAN

0.0 SCALE: 1/4"=1'-0"

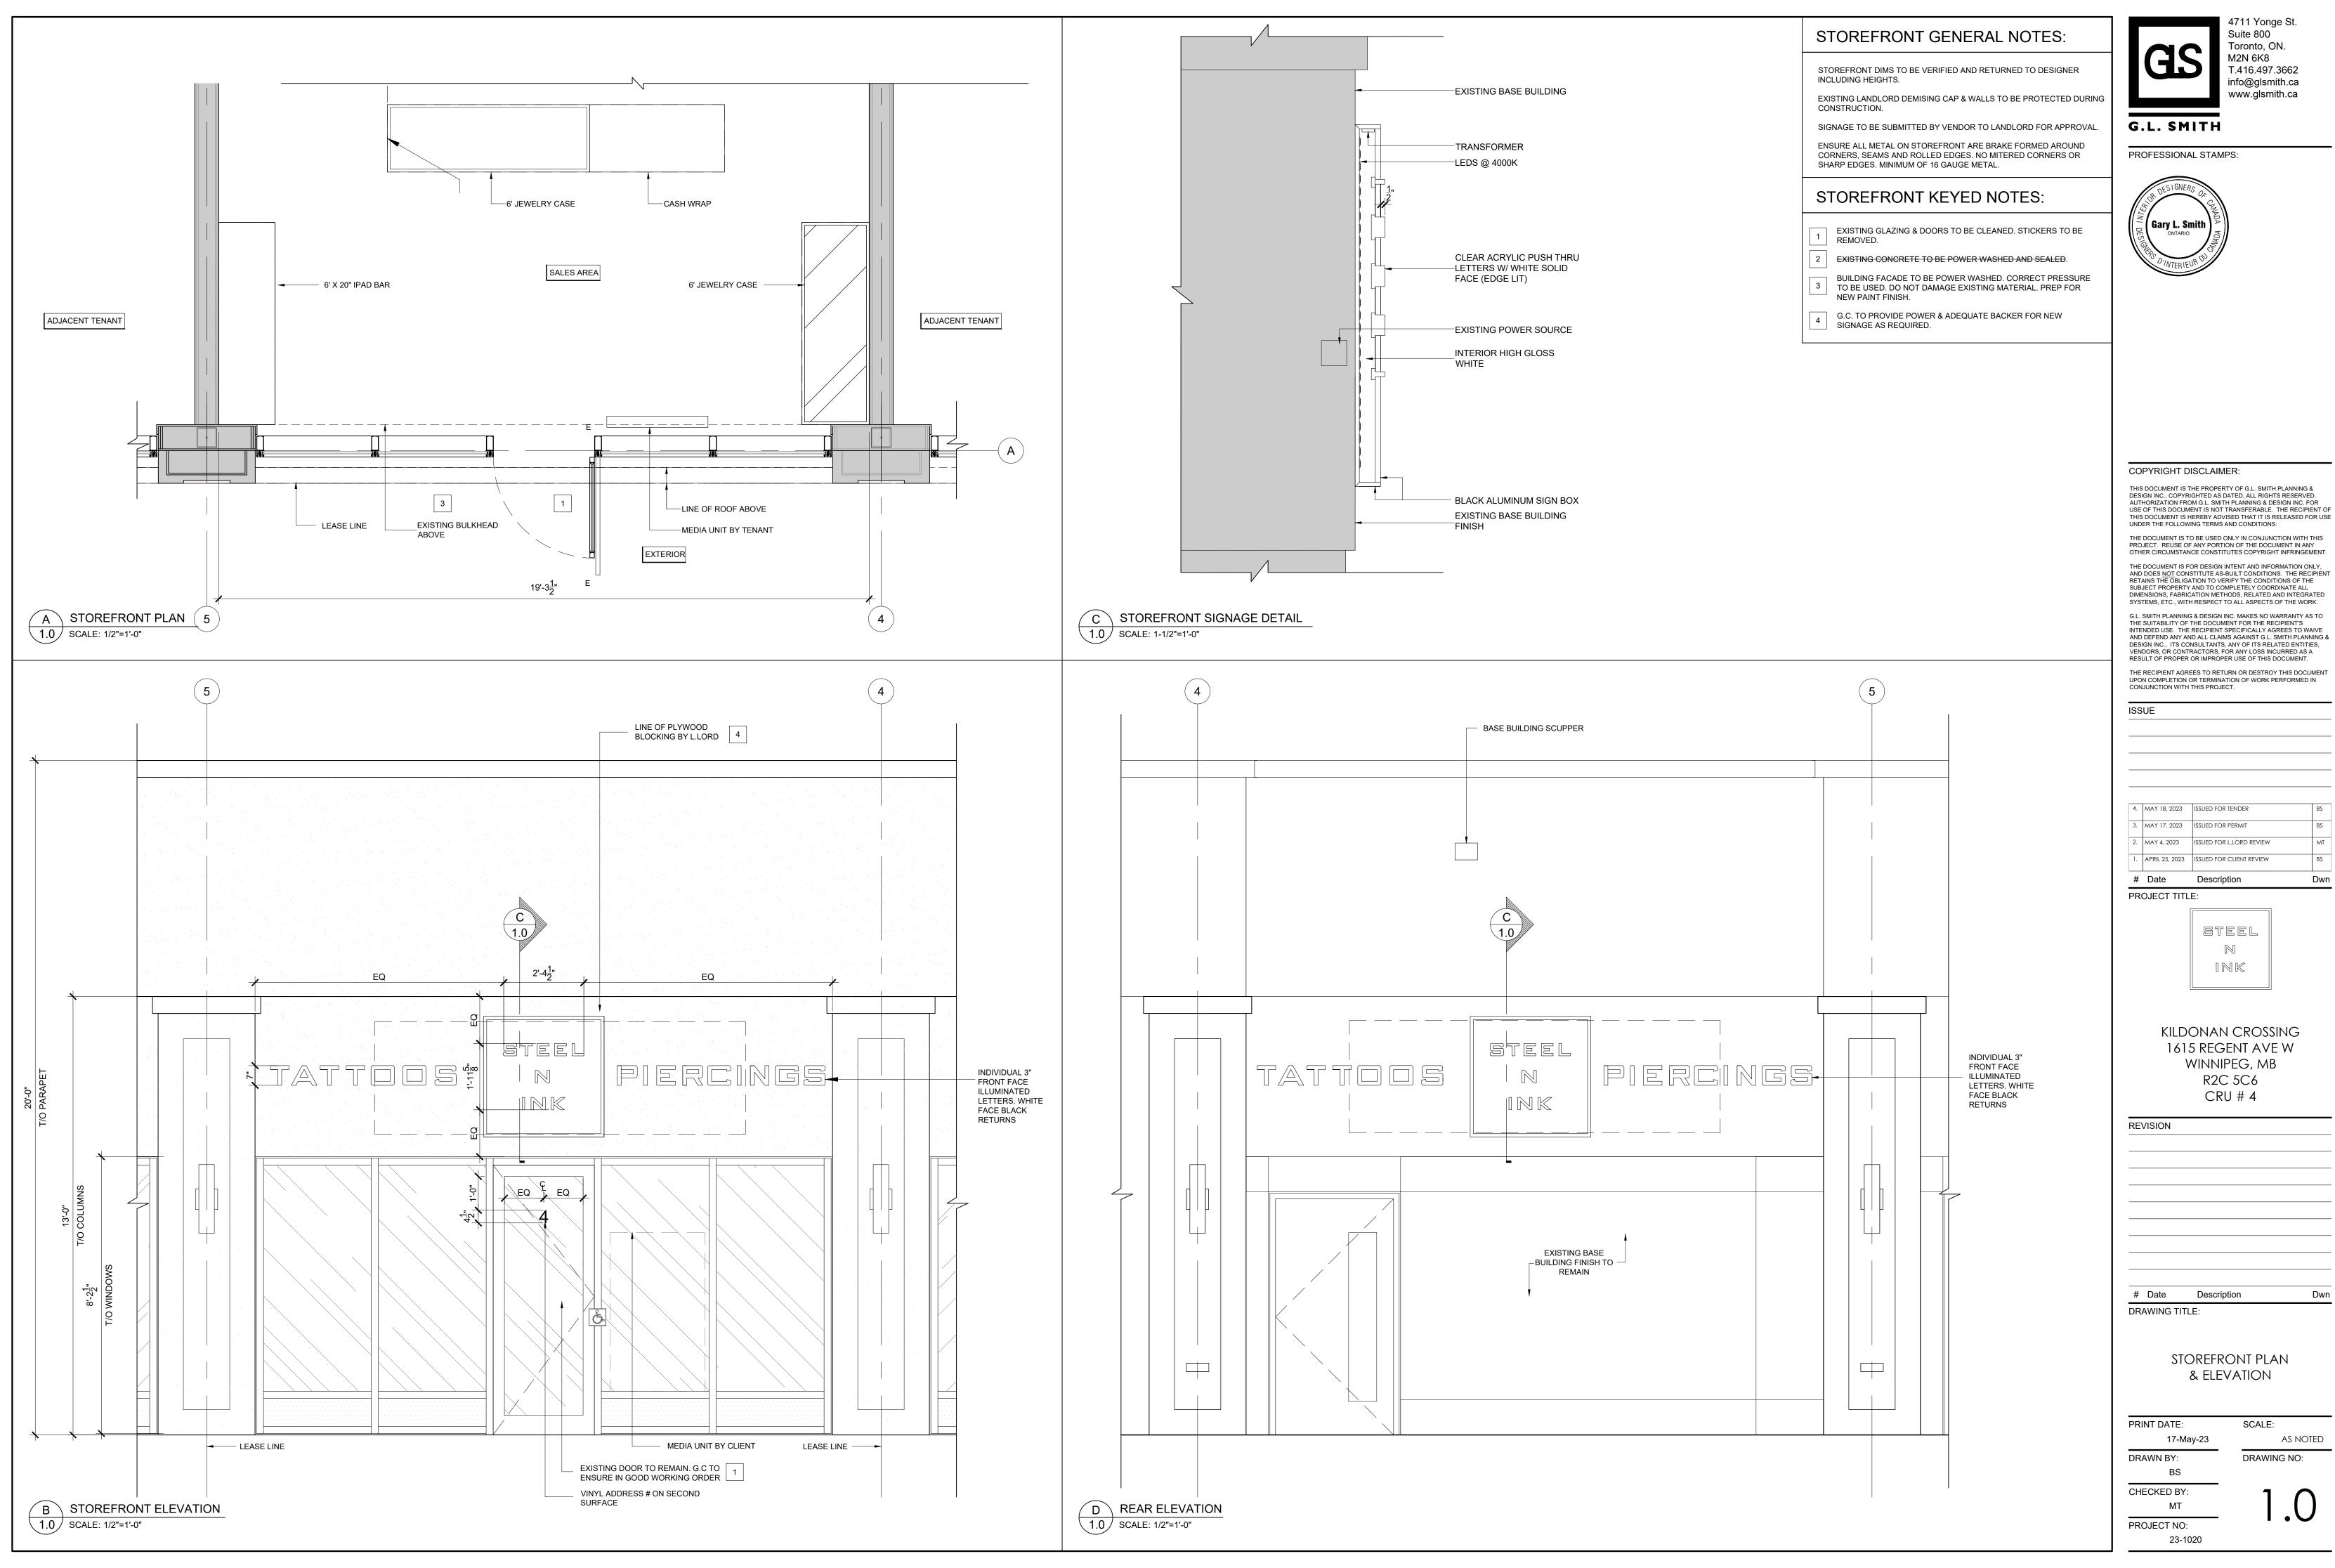

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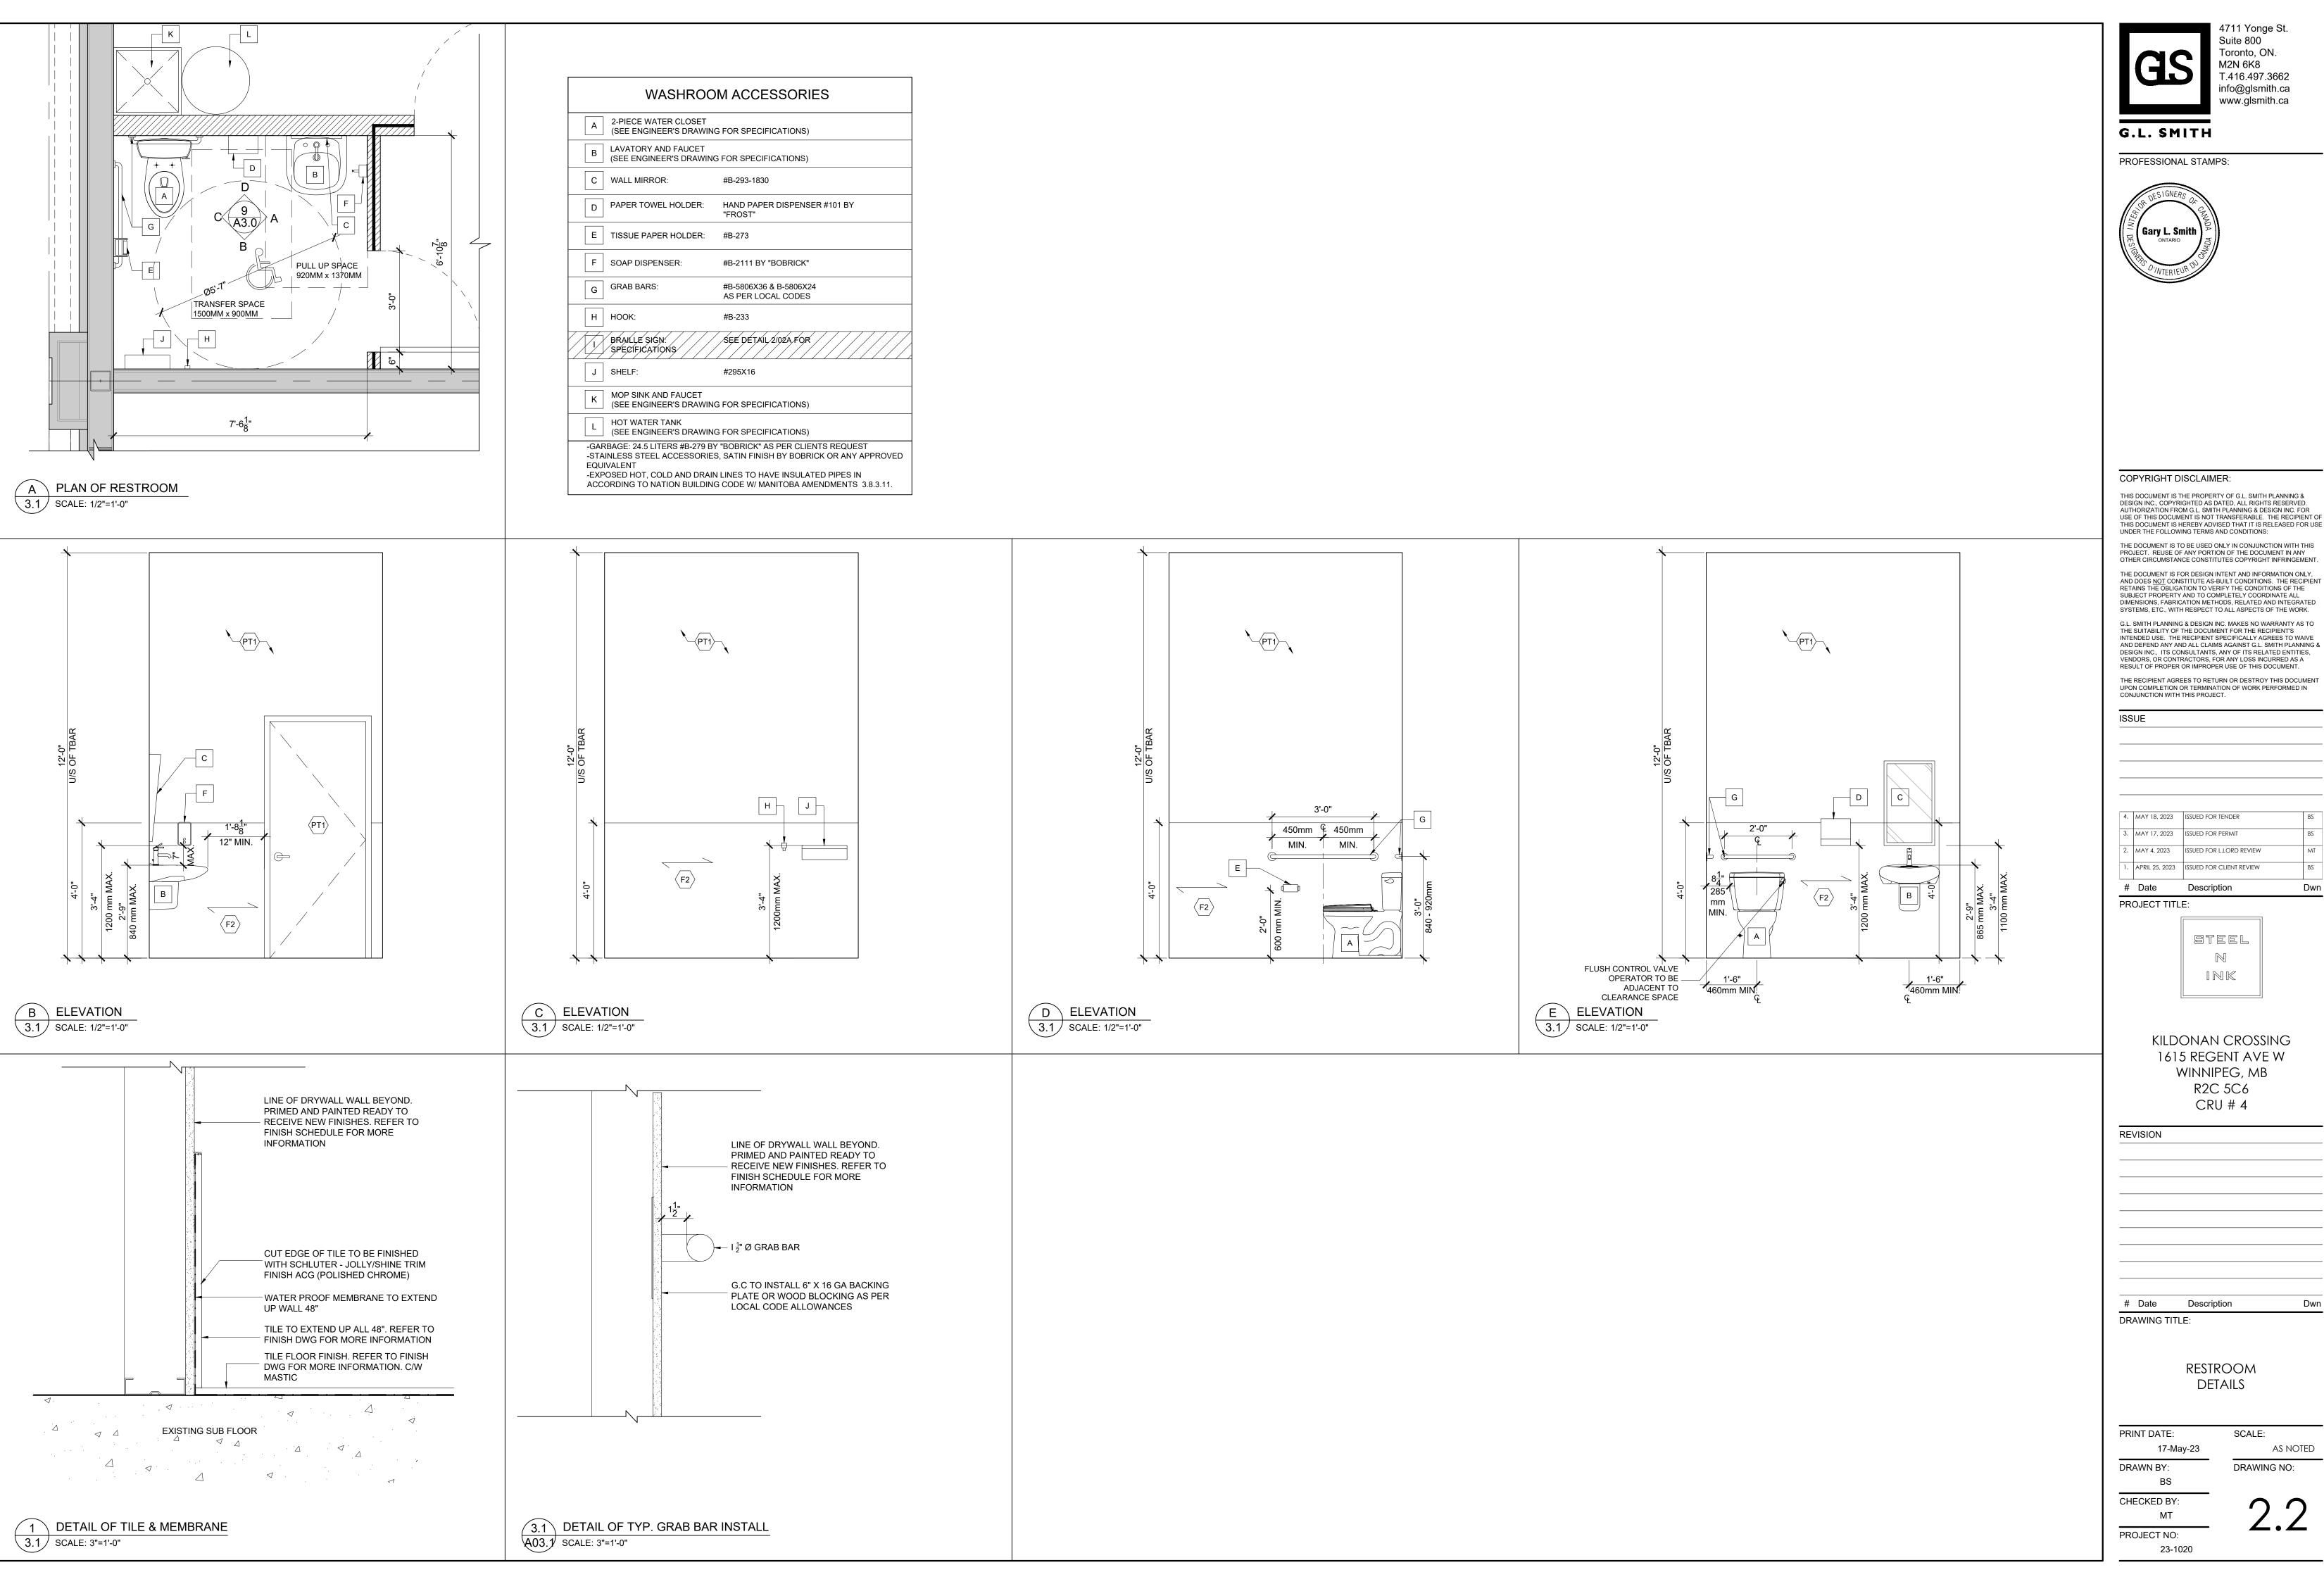
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4.	MAY 18, 2023	ISSUED FOR TENDER	BS
3.	MAY 17, 2023	ISSUED FOR PERMIT	BS
2.	MAY 4, 2023	ISSUED FOR L.LORD REVIEW	MT

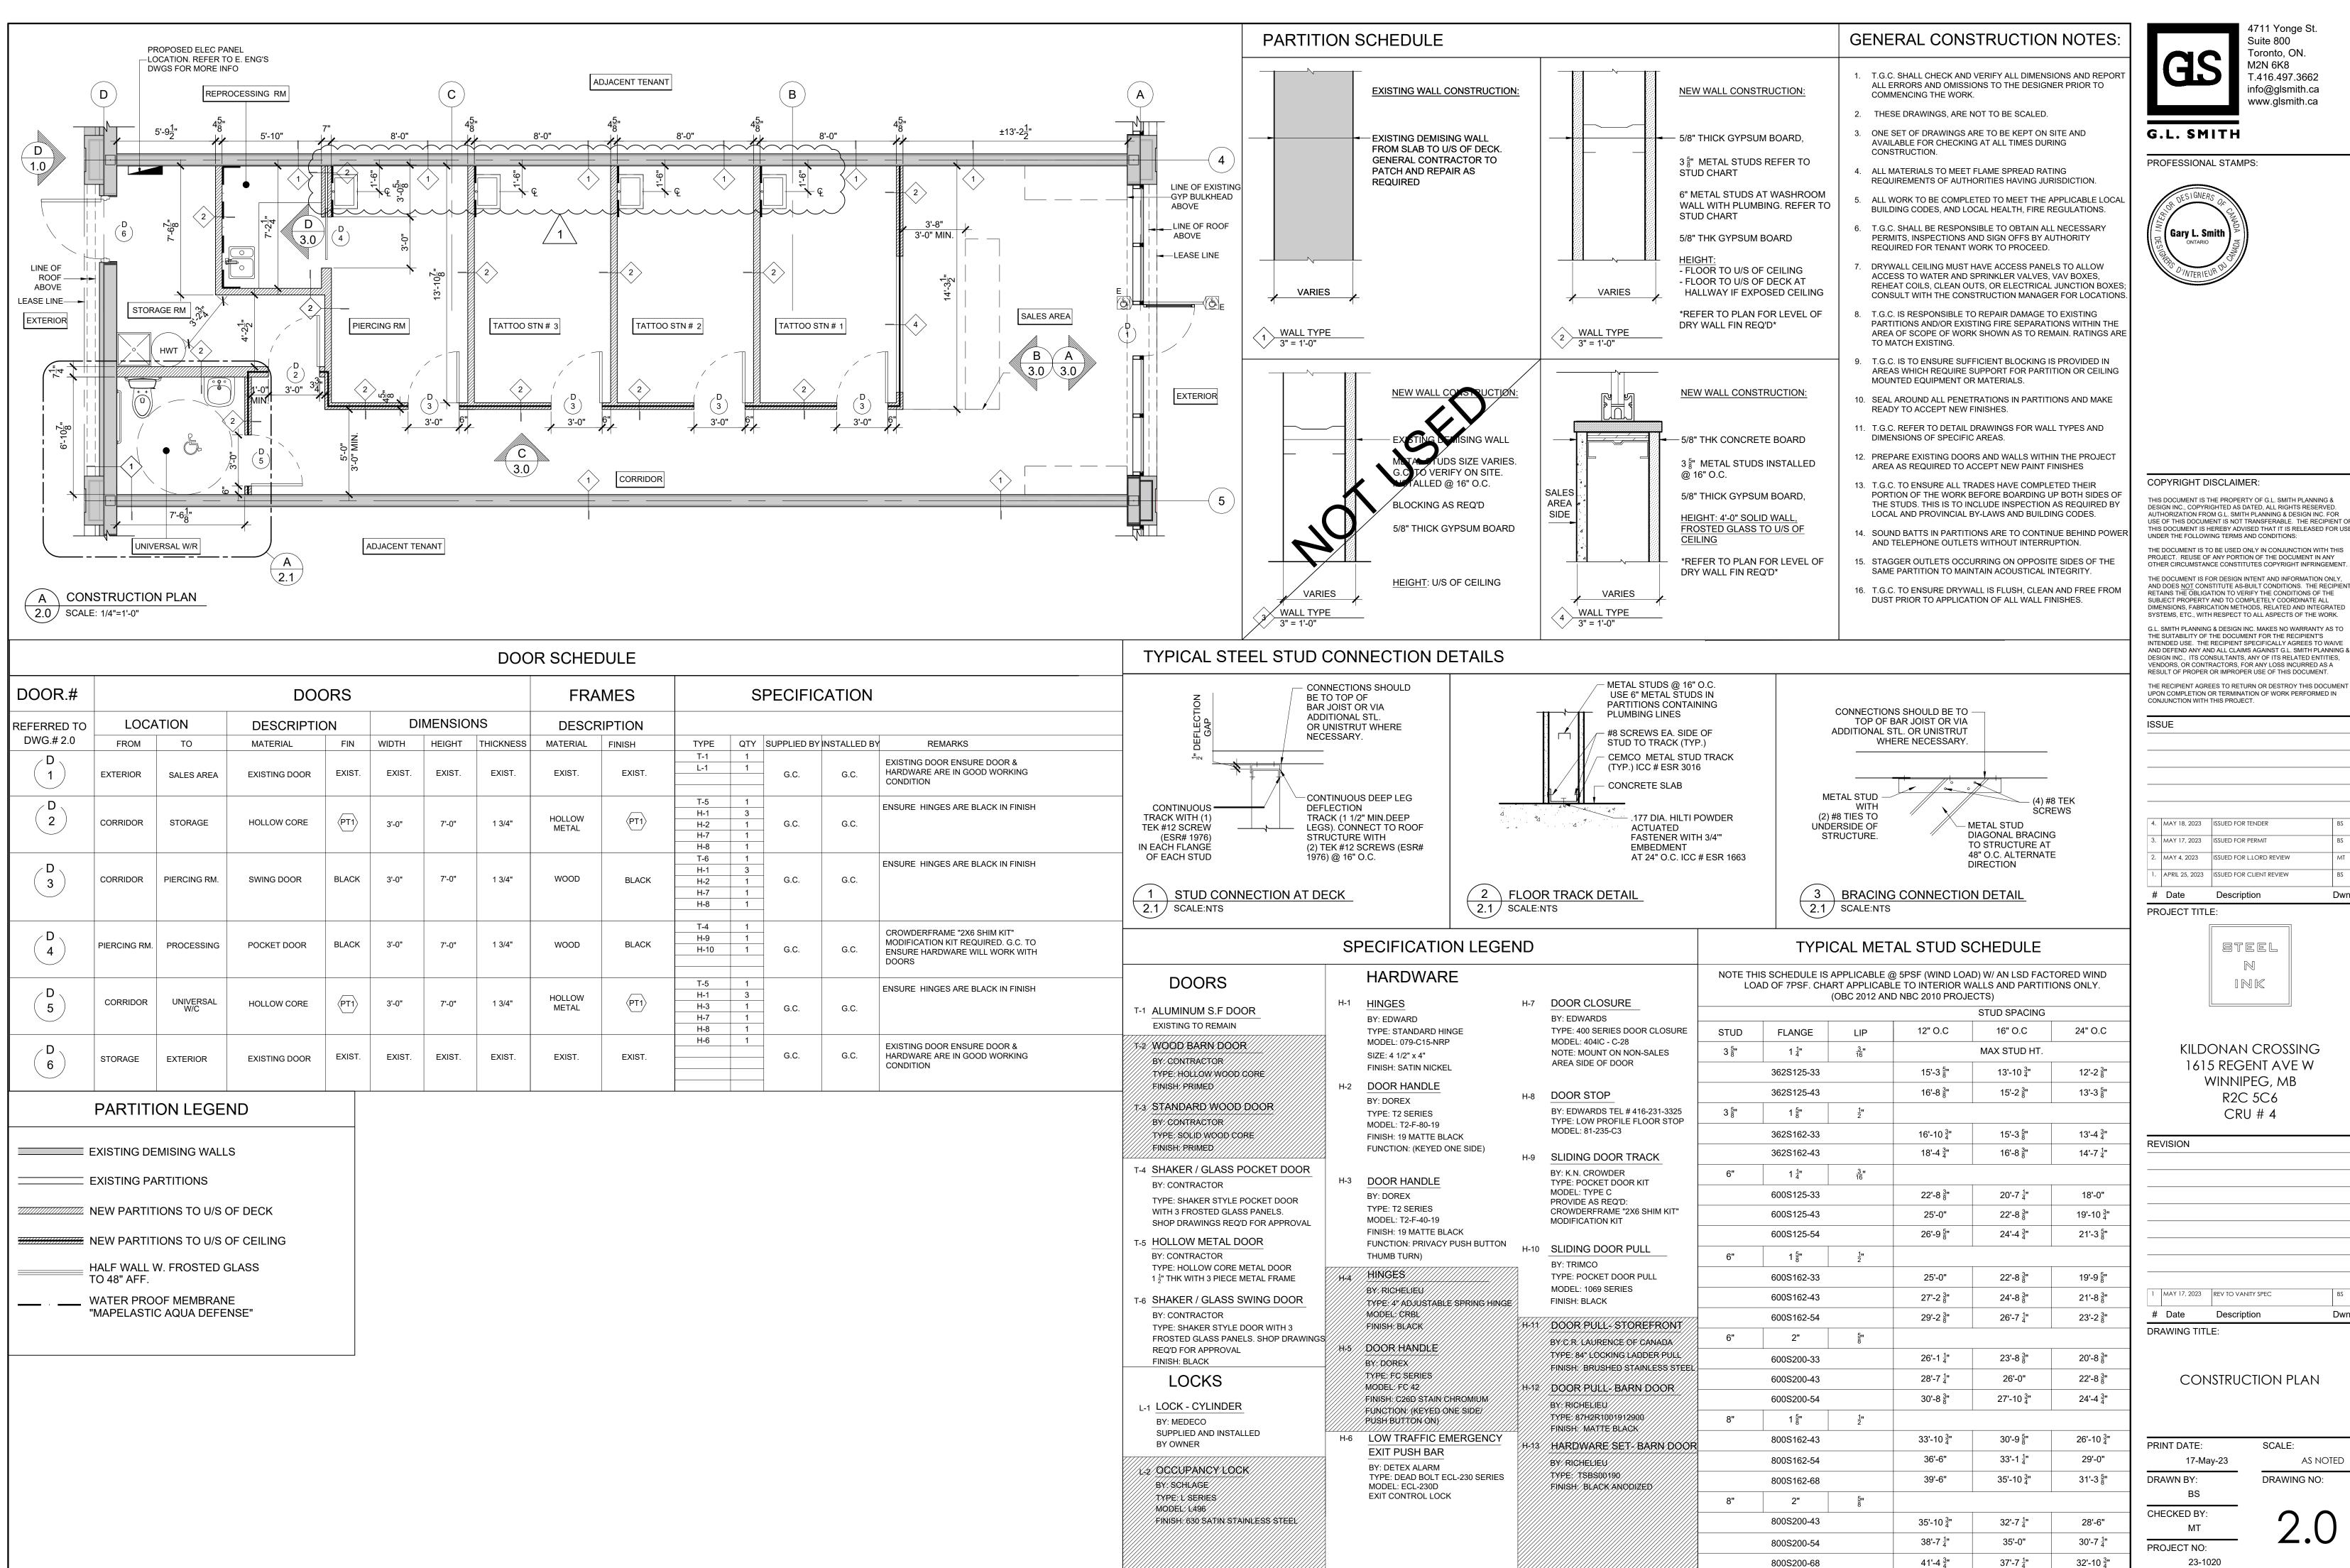KILDONAN CROSSING 1615 REGENT AVE W

1	MAY 17, 2023	REV TO VANITY SPEC	BS
	<b>I</b>		

RINT DATE:	SCALE:
17-May-23	AS NOTED
RAWN BY:	DRAWING NO:
BS	



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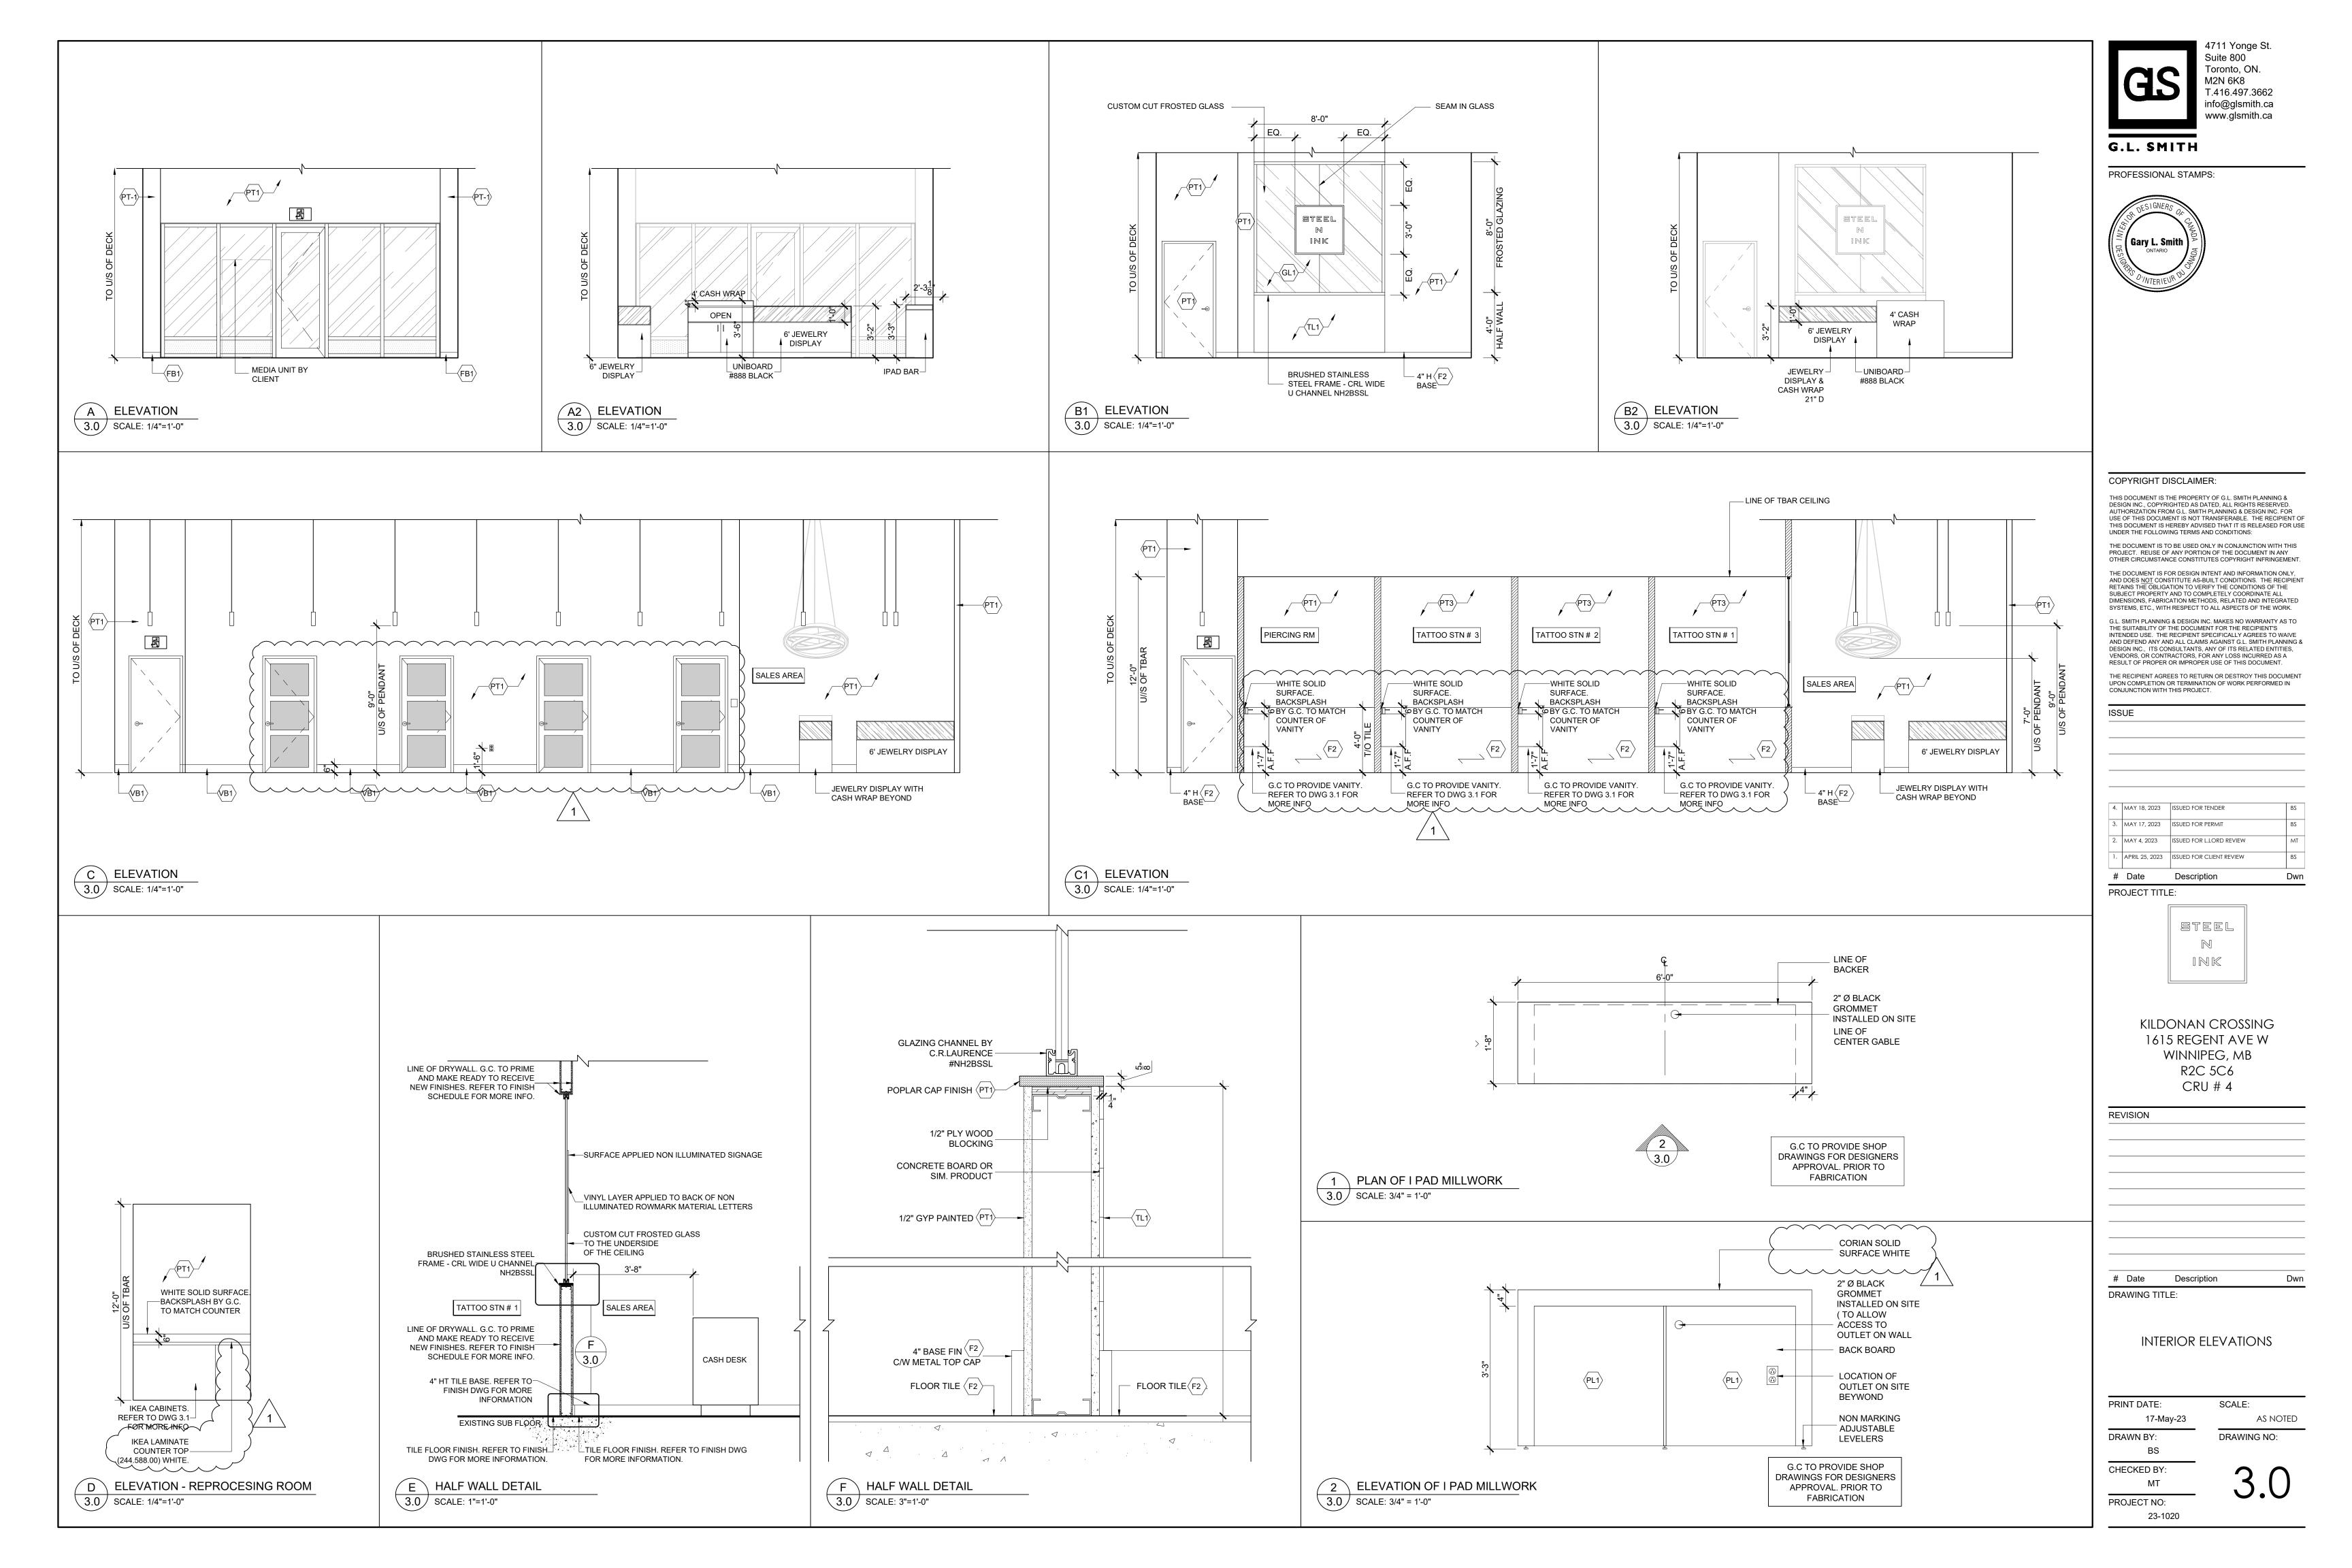
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3.	MAY 17, 2023	ISSUED FOR PERMIT	
2.	MAY 4, 2023	ISSUED FOR L.LORD REVIEW	
1.	APRIL 25, 2023	ISSUED FOR CLIENT REVIEW	

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	STEEL	
	INK	

KILDONAN CROSSING 1615 REGENT AVE W WINNIPEG, MB R2C 5C6

Date	Description	Dwn


PRINT DATE:	SCALE:
17-May-23	AS NOTED
DRAWN BY: BS	DRAWING NO:
CHECKED BY: MT	2.2



**Item list** 



#### COUNTERTOP TO BE WHITE. REFER TO DWG 5.0 FOR MORE INFO

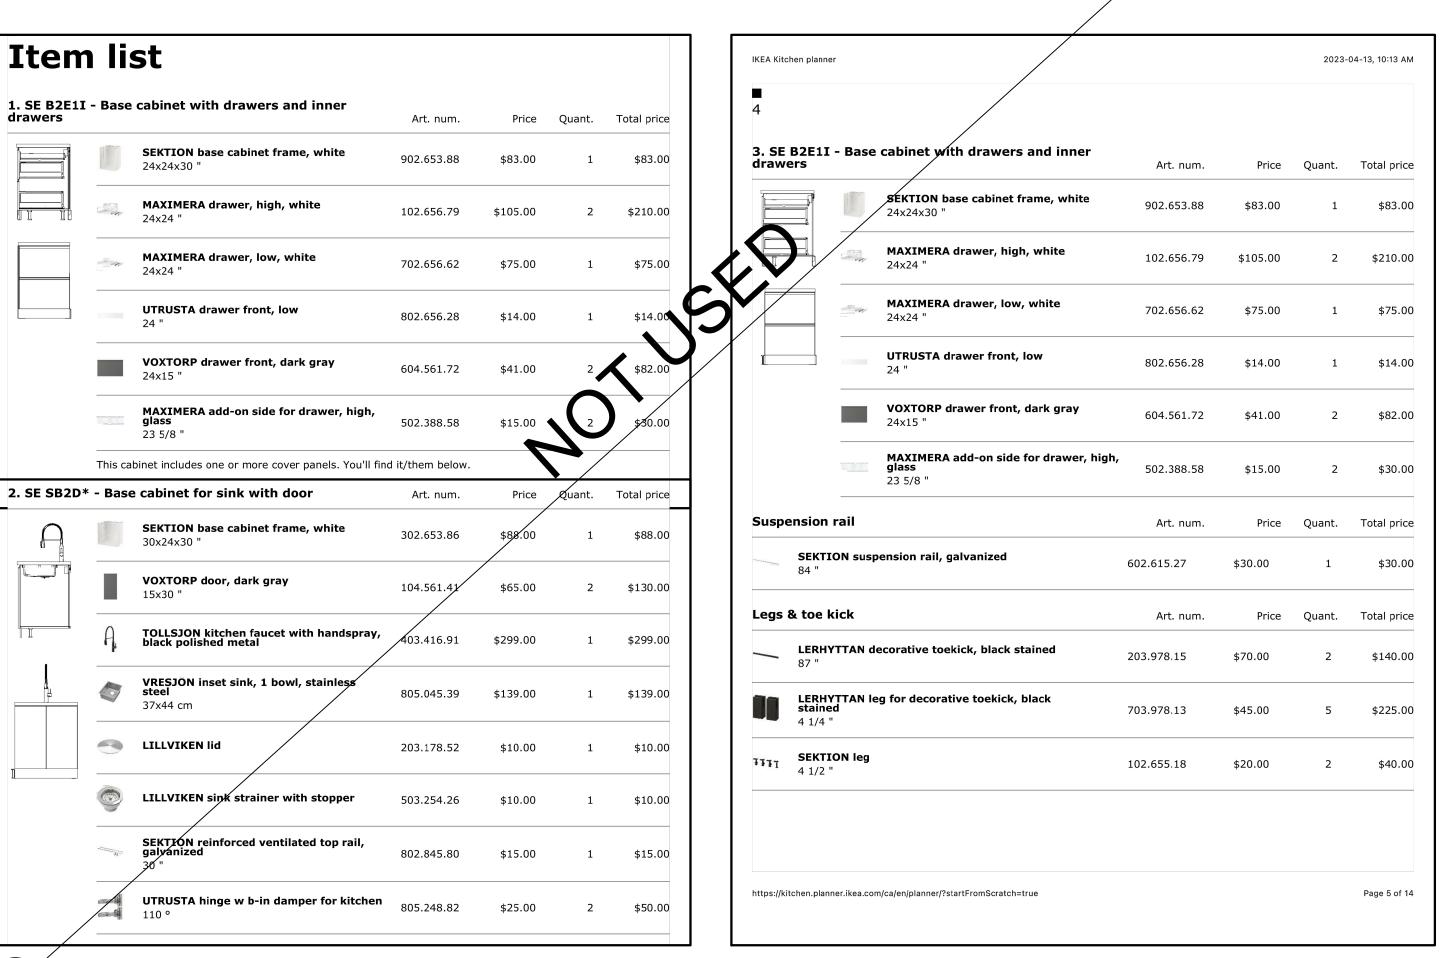

G.C TO PROVIDE BELOW IKEA MILLWORK + SINK + FAUCET OR SIMILAR. G.C TO CONFIRM DIMENSIONS ON SITE PRIOR TO PURCHASING



2023-04-13, 9:50 AM

Price Quant. Total price

1 \$83.00

3 \$270.00

3 \$36.00

2 \$56.00

1 \$140.00

\$92.00

Page 3 of 18

Price Quant. Total price

\$83.00

\$90.00

\$12.00

\$28.00

\$92.00

202.656.31 \$18.00 3 \$54.00

Art. num.

902.653.88

802.656.66

302.388.59

104.272.62

604.260.76

502.655.02 \$140.00

102.656.22 \$50.00

805.248.82 \$25.00



IKEA Kitchen planner 2023-04-13, 9:50 AM 5. SE SB2D\* - Base cabinet for sink with door Price Quant. Total price SEKTION base cabinet frame, white 802.653.98 \$93.00 36x24x30 ' 2 \$166.00 004.260.55 \$83.00 18x30 " VIMMERN kitchen faucet with handspray, stainless steel color 103.052.89 \$199.00 1 \$199.00 VRESJON inset sink, 1 bowl, stainle 805.045.39 \$139.00 1 \$139.00 37x44 cm LILLVIKEN lid 203.178.52 \$10.00 1 \$10.00 LILLVIKEN sink strainer with stopper 503.254.26 \$10.00 \$16.00 1 \$16.00 UTRUSTA hinge w b-in damper for kitchen \$25.00 2 \$50.00 Price Quant. Total price 602.615.27 \$60.00 Legs & toe kick Price Quant. Total price FORBATTRA toekick, matt white \$70.00

SEKTION leg 102.655.18 \$20.00 \$60.00

https://kitchen.planner.ikea.com/ca/en/planner/?startFromScratch=true

B MILLWORK - PROCESSING ROOM 3.1 SCALE: NTS

https://kitchen.planner.ikea.com/ca/en/planner/?startFromScratch=true

IKEA Kitchen planner

1. Filler piece - Filler piece for base cabinet

2. SE B2D3I\* - Base cabinet with inner drawers

24x24x30 "

12x30 "

23 5/8 "

3. SE CBS\* - Corner base cabinet with shelves

47x26x30 '

21x30 "

Filler pieces fill the gaps between cabinets or a wall and cabinet, and are made by cutting up cover panels.

**SEKTION** base cabinet frame, white

MAXIMERA drawer, medium, white

UTRUSTA drawer front, medium

MAXIMERA add-on side for drawer

UTRUSTA hinge w b-in damper for kitchen

AXSTAD door, matt white

UTRUSTA shelf for corner base cabinet

UTRUSTA hinge w b-in damper for kitchen

This cabinet includes one or more cover panels. You'll find it/them below.

AXSTAD door, matt white



A MILLWORK - TATTOO STN RM

3.1 SCALE: NTS

3.1 SCALE: NTS

Agostini 24" Single Bathroom Vanity with Resin Vanity


See More by Steelside™

★★★★ 4.6 <u>109 Reviews</u>

\$529.99 \$757.39 30% Off On Sale


Get \$25 off \$150 with the Wayfair Credit Card 1

Get it between Thu. May 25 – Mon. May 29 Ship to: M4C 1B5 - Toronto V

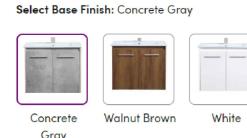


Add to Cart

C MILLWORK - TATTOO STN VANITY 3.1 SCALE: NTS

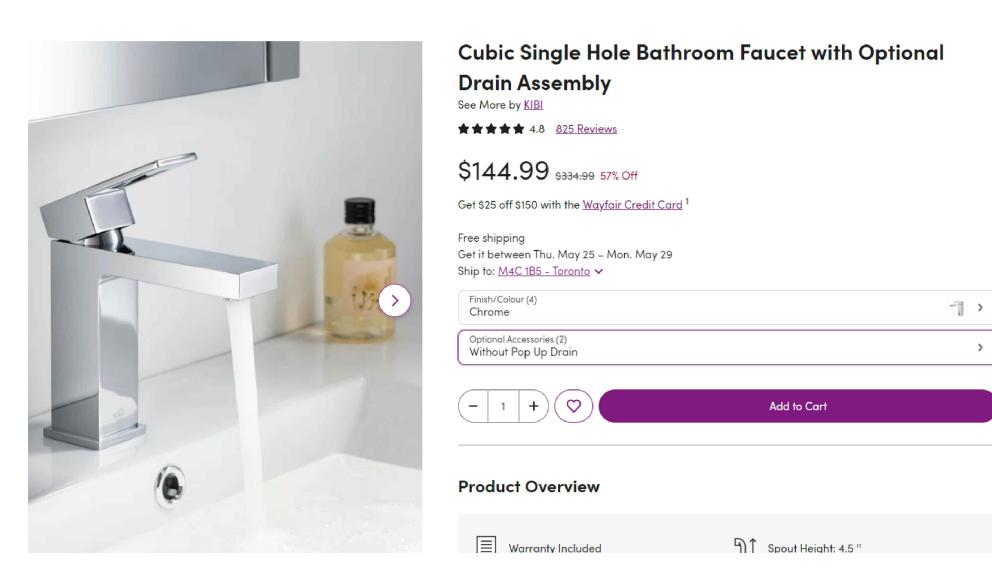

D MILLWORK - TATTOO STN FAUCET

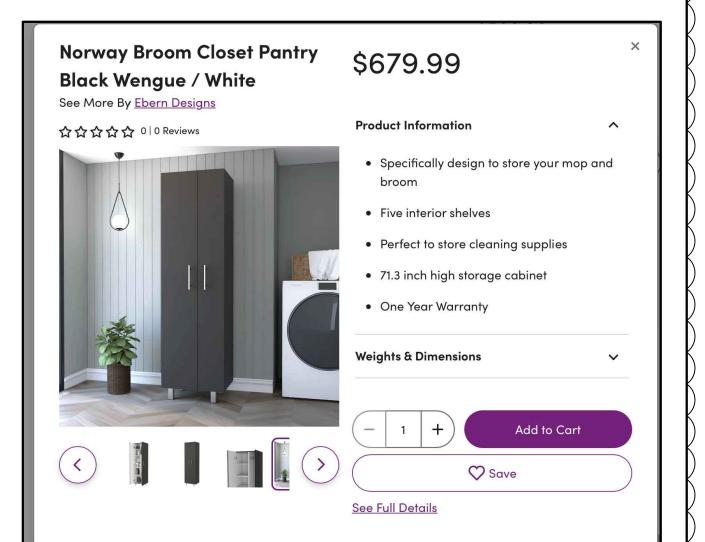

E MILLWORK - TATTOO STN STORAGE 3.1 SCALE: NTS



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4.	MAY 18, 2023	ISSUED FOR TENDER	BS
4.	MAY 18, 2023 MAY 17, 2023	ISSUED FOR TENDER	BS BS
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# Date Description PROJECT TITLE:

Page 4 of 18

ISSUE

STEEL  $\mathbb{N}$ INK

KILDONAN CROSSING 1615 REGENT AVE W WINNIPEG, MB R2C 5C6


		CRU # 4	
RE	VISION		
1	MAY 17, 2023	REV TO VANITY AND MILLWORK DETAILS	BS

MILLWORK DETAILS

# Date Description

DRAWING TITLE:

RINT DATE:	SCALE:
17-May-23	AS NO
RAWN BY:	DRAWING NO:
BS	
HECKED BY:	

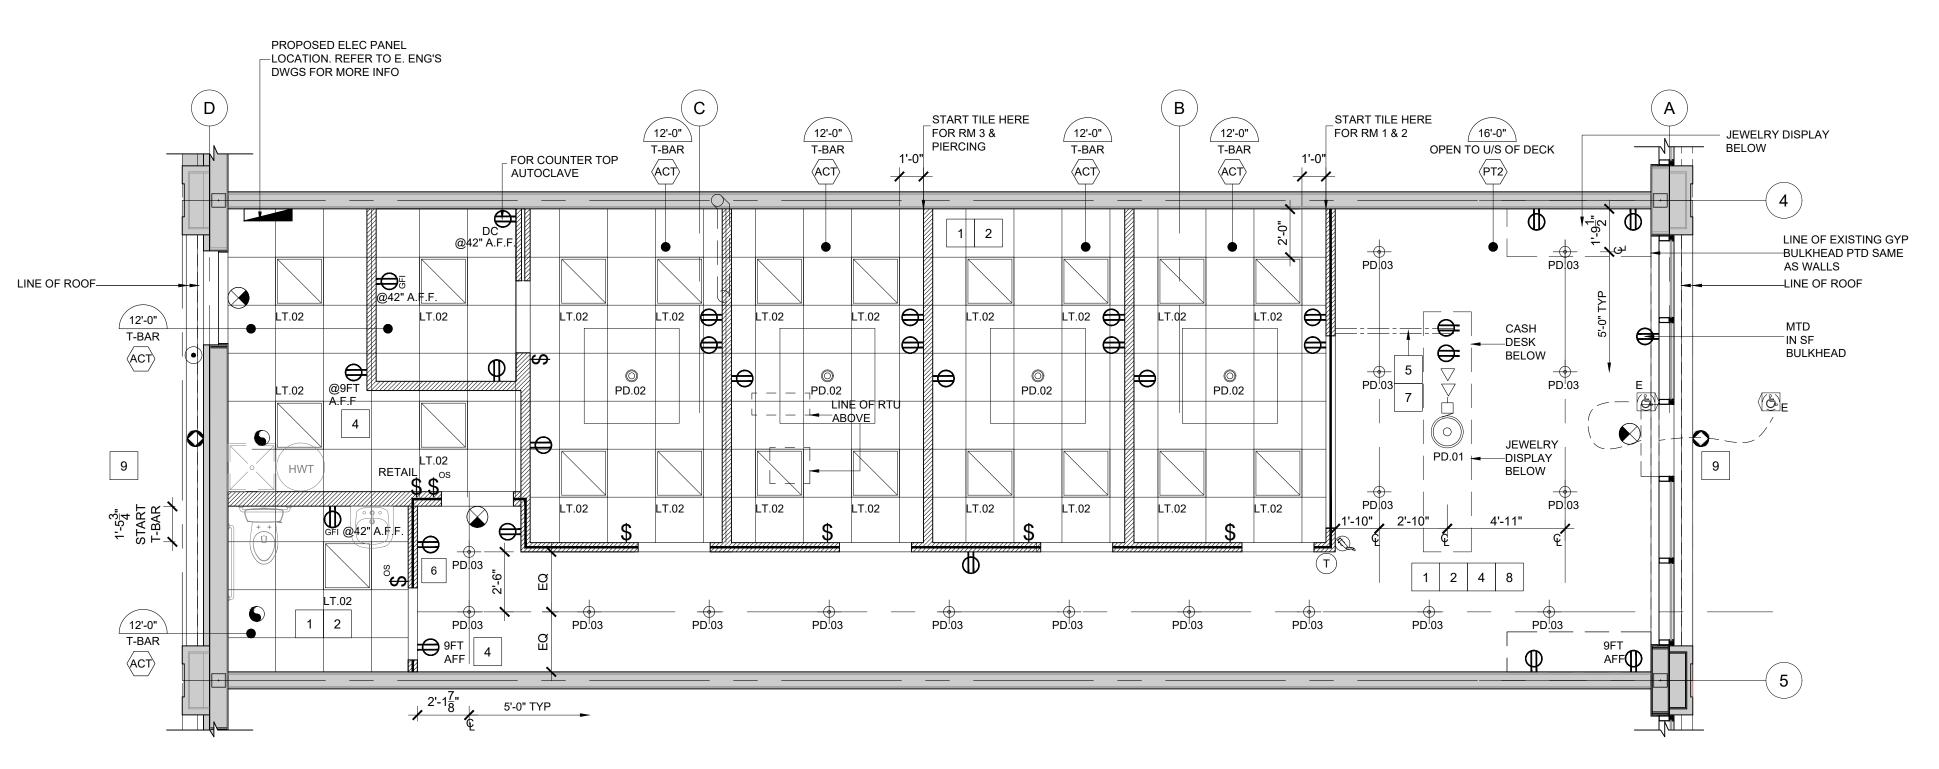

A REFLECTED CEILING PLAN
4.0 SCALE: 1/4"=1'-0"

P KEYED NOTES:	GENERAL RCP NOTES:	GENERAL POWER & COMM. NOTES:	
G.C. TO ENSURE THAT ALL DIFFUSERS AND ACCESS HATCHES ARE PAINTED THE SAME COLOUR AS CEILING.  MAINTAIN/PROVIDE ACCESS TO ALL BASE BUILDING AND TENANT INSTALLED EQUIPMENT ABOVE THE CEILING THAT MAY REQUIRE PERIODIC SERVICE OR MAINTENANCE. COORDINATE WITH THE LANDLORDS BUILDING OPERATIONS MANAGER  ALL SPRINKLER HEADS ARE TO BE RECESSED AND W/BLACK GOVER  POWER FOR SECURITY CAMERA, FACE PLATE & FIXTURE TO BE SAME AS ADJACENT WALLS  T.G.C TO TRENCH AS NOTED W/ (2) SEPARATE 3/4" DIAMETER CONDUITS, ONE FOR POWER AND ONE FOR COMMUNICATION-SEE ENG'S DWGS FOR MORE INFO. ALL SUPPLIED, INSTALLED & TERMINATED BY G.C.  POWER FOR TENANT SUPPLIED SIGN. POWER TO BE ON A TIME CLOCK  ALL CABLING TO BE CAT6.  ALARM CABLING BY OTHERS. ALL OTHER CABLING UNLESS NOTED OTHERWISE TO BE BY G.C.  G.C. TO PROVIDE POWER FOR ALL EXTERIOR SIGNAGE IF NONE EXISTING. FINAL CONNECTION BY G.C. ELECTRICIAN. PROVIDE A TIMER IF REQ'D.	<ol> <li>REFER TO THE MECHANICAL ENGINEER DRAWINGS FOR THE HVAC DISTRIBUTION AND DESIGN.</li> <li>REFER TO THE ELECTRICAL ENGINEER DRAWINGS FOR ALL LIGHTING, CONTROLS AND SWITCHING. COORDINATE THEIR DRAWINGS WITH THE DESIGN DRAWINGS FOR LIGHT FIXTURE MOUNTING HEIGHTS. GENERAL CONTRACTOR IS TO PROVIDE ALL LIFE/SAFETY EXIT LIGHTING AS PER THE ELECTRICAL ENGINEERS' DRAWINGS.</li> <li>ALL SURFACES EXISTING AS WELL AS ALL NEW HVAC DISTRIBUTION IS TO BE PAINTED OUT TO MATCH CEILING.</li> <li>STOREFRONT SIGNAGE TO ADHERE TO APPLICABLE CITY BY-LAWS.</li> <li>ALL NEW FIXTURES TO BE U.L.C. LISTED AND FURNISHED BY OWNER VENDOR, INSTALLED BY CONTRACTOR. CONTRACTOR TO CONFORM TO ALL APPLICABLE LOCAL CODES AND INSTALL PER MANUFACTURER SPECIFICATIONS.</li> </ol>	<ol> <li>POWER AND COMMUNICATION DRAWINGS TO BE USED FOR LOCATION PURPOSES ONLY. REFER TO ELECTRICAL DRAWINGS FOR DETAILS, SPECIFICATIONS AND REQUIREMENTS. REPORT ANY DISCREPANCIES.</li> <li>ALL MECHANICAL, ELECTRICAL AND COMMUNICATION WORK TO COMPLY WITH THE REQUIREMENTS OF THE BUILDING LANDLORD AND AUTHORITIES HAVING JURISDICTION.</li> <li>ALL MATERIALS AND LABOURS BY T.G.C. U.O.N.</li> <li>ALL CAT 6 CABLES TO BE TERMINATED (KEYSTONE PLATED) AND LABELED BY T.G.C.</li> <li>NEW POWER/VOICE/DATA RECEPTACLES ARE TO BE MOUNTED AT 16" AFF. TO THE CENTERLINE OF THE DEVICE UNLESS OTHERWISE NOTED. ALL SWITCHES ARE TO BE MOUNTED SO THAT THE CENTER LINE OF THE DEVICE ALIGNS WITH THE CENTER LINE OF THE DOOR HARDWARE. ALL CONDUIT AND WIRING IS TO BE CONCEALED WITHIN WALLS, ALSO COORDINATE WITH MILLWORK.</li> </ol>	<ol> <li>DIMENSIONS TAKEN FROM THE FACE OF THE PARTITION TO THE CENTRE OF THE SERVICE OR GROUP OF SERVICES U.O.N.</li> <li>WHERE POWER AND COMMUNICATION SERVICES ARE ADJACENT ON PLAN, GANGED COVER PLATES SHALL BE USED.</li> <li>CONTRACTOR TO ENSURE TRADES HAVE COMPLETED THEIR PORTION OF THE WORK BEFORE BOARDING UP BOTH SIDES OF STUDS. THIS IS TO INCLUDE INSPECTIONS AS REQUIRED BY LOCAL AND PROVINCIAL BY-LAWS AND BUILDING CODES.</li> <li>CONTRACTOR TO SUPPLY AND INSTALL EMPTY CONDUIT, C/W PULL STRINGS, WIRING, CONNECTIONS AND BOXES FOR ALL SECURITY AND CABLE TELEVISION WIRING.</li> <li>WHERE POWER AND COMMUNICATION ARE SHOWN ON A COLUMN, CENTER GANG ON COLUMN U.O.N.</li> <li>ALL COVER PLATES AND RECEPTACLES AND SWITCHES TO MATCH WALL FINISH U.O.N.</li> </ol>

E = EXISTING N = NEW D = DEMO	R = RELOCATED			ELEC	CTRICAL LEGEND					THE RECIPIENT AGREES TO P UPON COMPLETION OR TERM CONJUNCTION WITH THIS PR
ITEM#	SYMBOL	QTY.	DESCRIPTION	MFG	MODEL#	BULB	V	W	REMARKS	ISSUE
1.	PD.01	1	DECORATIVE PENDANT	MODERN FORMS LIGHTING	PD-24848-BK	LED		107W	SUSPENDED AT 7'-0" AFF	
2.	© PD.02	4	DECORATIVE PENDANT	KUZCO LIGHTING	PD88148-BK	LED		100W	SUSPENDED AT 7'-0" AFF	
3.	PD.03	17	GENERAL LIGHTING	LIGHTOLIER	3DP-CY-BKST-LC-S-DI-BK- BK-E26-PAR38	LED	120V	15W	SUSPENDED AT 9'-0" AFF C/W COMPATIBLE PHILIPS 14PAR38/LED/835/F25/GL/DIM LAMP	4. MAY 18, 2023 ISSUED  3. MAY 17, 2023 ISSUED
4.	DL:01	0	SINGLE SPØT	STANPRO	6780-LPDL4/RND/9W/5C C7/BK/S7D	LED/		9W		2. MAY 4, 2023 ISSUED  1. APRIL 25, 2023 ISSUED
5.	LT.02	21	2X2 LED LIGHT PANEL	FEIT ELECTRIC	FP2X2/4U WY/WH (SPECIFY SURFACE MTD TRIM KIT AS REQ'D)	LED		48W	FOR NEW T-BAR CEILING INSTALL	# Date Desc
6.		2=E	RECESSED SPEAKERS						SEE ENG DWG'S FOR MORE INFO	
7.	20	SEE ENGINEER DWGS	DOUBLE HEAD EMERGENCY LIGHT	STANPRO	STAN-N2-06-12V4WLJ				SEE ENG DWG'S FOR MORE INFO	
8.		SEE ENGINEER DWGS	DOUBLE HEAD EMERGENCY LIGHT WITH BATTERY PACK	STANPRO	STAN-SLC12200-2N3WLJ-2H				SEE ENG DWG'S FOR MORE INFO	
9.		SEE ENGINEER DWGS	COMBO EXIT SIGN DOUBLE HEAD EMERGENCY LIGHT	STANPRO	STAN,PRMS-2L				SEE ENG DWG'S FOR MORE INFO	KILDON <i>A</i> 1615 RE
10.	$\bigotimes$	SEE ENGINEER DWGS	ILLUMINATED EXIT SIGN SINGLE FACE EXIT	STANPRO	STAN-RMS-0-WH-UDC				SEE ENG DWG'S FOR MORE INFO	WINI R2
11.	T	1	THERMOSTAT LOCATION						SEE ENG DWG'S FOR MORE INFO	C
12.		SEE PLAN	ELECTRICAL PANEL LOCATION						SEE ENG DWG'S FOR MORE INFO	REVISION
13.	Ø	2	MULTI PURPOSE DRY CHEMICAL FIRE EXTINGUISHER						SEE ENG DWG'S FOR MORE INFO	
14.	Ф	25	DUPLEX OUTLET SINGLE PHASE 15A/120V						SEE ENG DWG'S FOR MORE INFO. FACE PLATE COLOUR TO MATCH W/ WALL FIN.	
15.	GFI	2	GROUND FAULT INTERRUPTER DUPLEX OUTLET SINGLE PHASE 15A/120V						SEE ENG DWG'S FOR MORE INFO. FACE PLATE COLOUR TO MATCH W/ WALL FIN.	
16.	DC	1	DIRECT CONNECTION DUPLEX OUTLET SINGLE PHASE 15A/120V						SEE ENG DWG'S FOR MORE INFO. FACE PLATE COLOUR TO MATCH W/ WALL FIN.	1 MAY 17, 2023 REV TO # Date Desc
17.	Φ	0	FLOOR MONUMENT DUPLEX						SEE ENG DWG'S FOR SPEC. SILVER COVER PLATE	DRAWING TITLE:
18.	$\nabla$	2	DATA PORT CAT 6						SEE ENG DWG'S FOR MORE INFO	REFLECTED
19.	<b>(&amp;)</b>	2 = E	PUSH BUTTON OPERATOR						EXISTING BY L.LORD	COMMUNI
20.	• / <del>[</del>	1 BELL 1 BUZZER	BELL & BUZZER						SEE ENG DWG'S FOR MORE INFO	PRINT DATE: 17-May-23
21.	0	2	DIRECT CONNECT FOR HARDWIRED SIGNAGE. POWER ON TIME CLOCK						STOREFRONT SIGN ON TIME CLOCK. SEE ENG DWG'S FOR MORE INFO	1
22.	\$	6	SINGLE POLE TOGGLE SWITCH						SEE ENG DWG'S FOR MORE INFO	CHECKED BY:
23.	\$°s	2	OCCUPANCY SENSOR						SEE ENG DWG'S FOR MORE INFO	PROJECT NO: 23-1020



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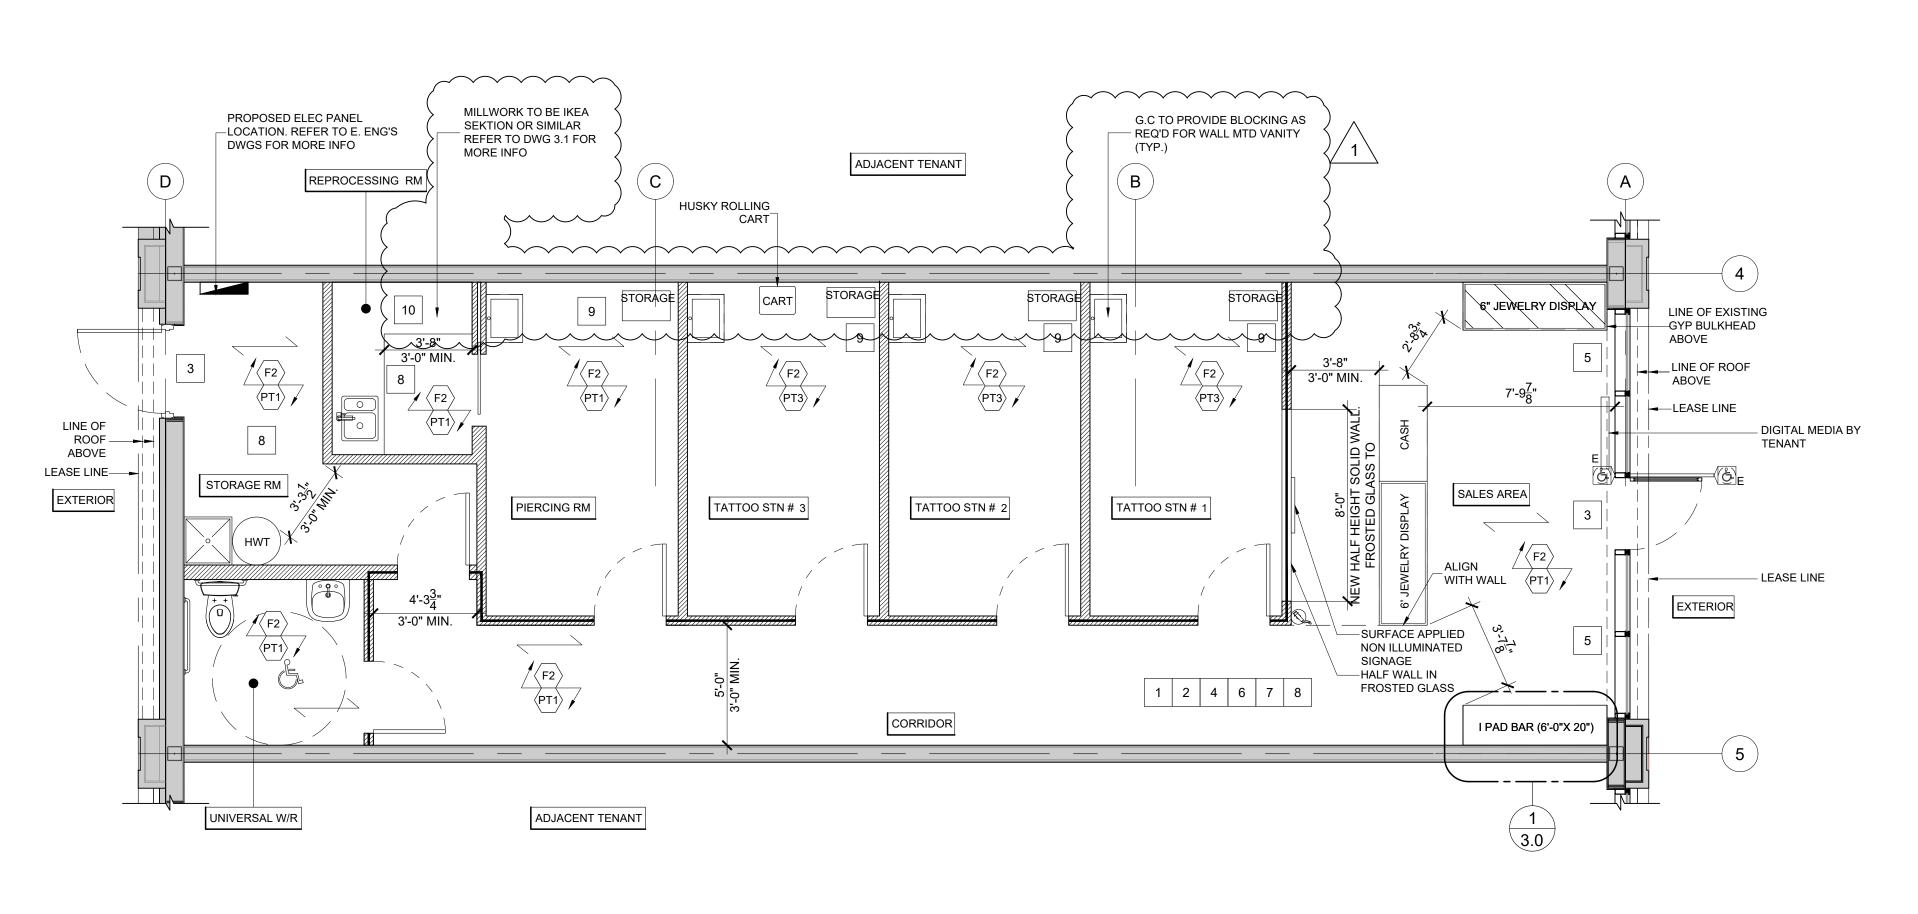
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KILDONAN CROSSING 1615 REGENT AVE W WINNIPEG, MB R2C 5C6 CRU # 4

#	Date	Description	Dwr
1	MAY 17, 2023	REV TO VANITY AND STORAGE DETAILS	BS


REFLECTED CEILING AND COMMUNICATIONS PLANS

INT DATE:	SCA
17-May-23	
AWN BY:	DRA
BS	
IECKED BY:	•
MT	,



A FINISHES PLAN 5.0 SCALE: 1/4"=1'-0"

IKEA LAMINATE COUNTER TOP (244.588.00) WHITE. G.C TO

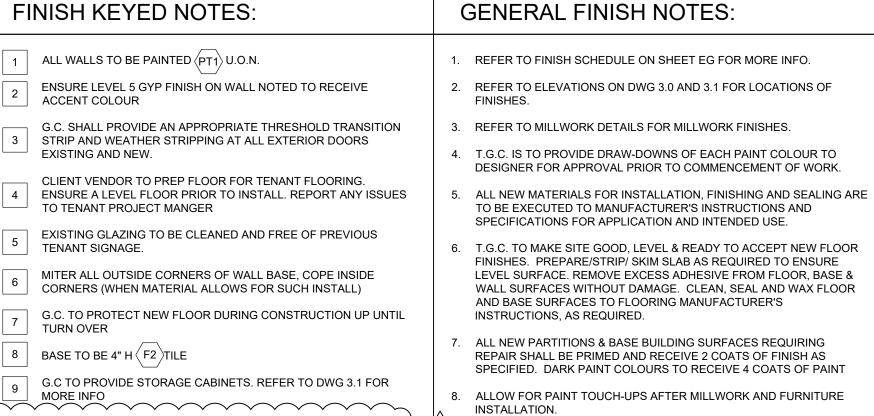


T.G.C. TO ENSURE THAT ALL DRYWALL IS FLUSH, CLEAN AND FREE FROM DUST PRIOR TO APPLICATION OF ALL WALL FINISHES. 0. MAKE GOOD ALL EXISTING AREAS AFFECTED BY CONSTRUCTION OR DEMOLITION AND ANY SURFACES NOTED AS EXISTING. 11. ALL FINISHES TO CONFORM TO MINIMUM FLAME SPREAD RATING AND 12. INSTALL TILE ON FLOORS WITH STRAIGHT 1/4" GROUT JOINT U.N.O 13. G.C TO PROTECT FLOORING FROM DAMAGE DURING FIXTURE DELIVERY AND INSTALLATION. 14. PAINTER SHALL BE RESPONSIBLE FOR THE REMOVAL OF HARDWARE, SWITCH AND OUTLET COVERS,ETC,AND REINSTALLATION OF SAME

15. ALL EXPOSED PIPING, DUCTWORK, REGISTERS, CONDUITS, ALL THREAD, OR ANY OTHER ITEMS EXPOSED IN CEILING AREAS SHALL BE PAINTED TO MATCH CEILING COLOUR UNLESS PROHIBITED BY BUILDING OR FIRE CODES.

AFTER PAINTING.

16. AT COMPLETION OF PAINTING, ALL PAINT MATERIALS AND EQUIPMENT SHALL BE REMOVED, ALL PAINT SPOTS REMOVED, AND ALL AREAS

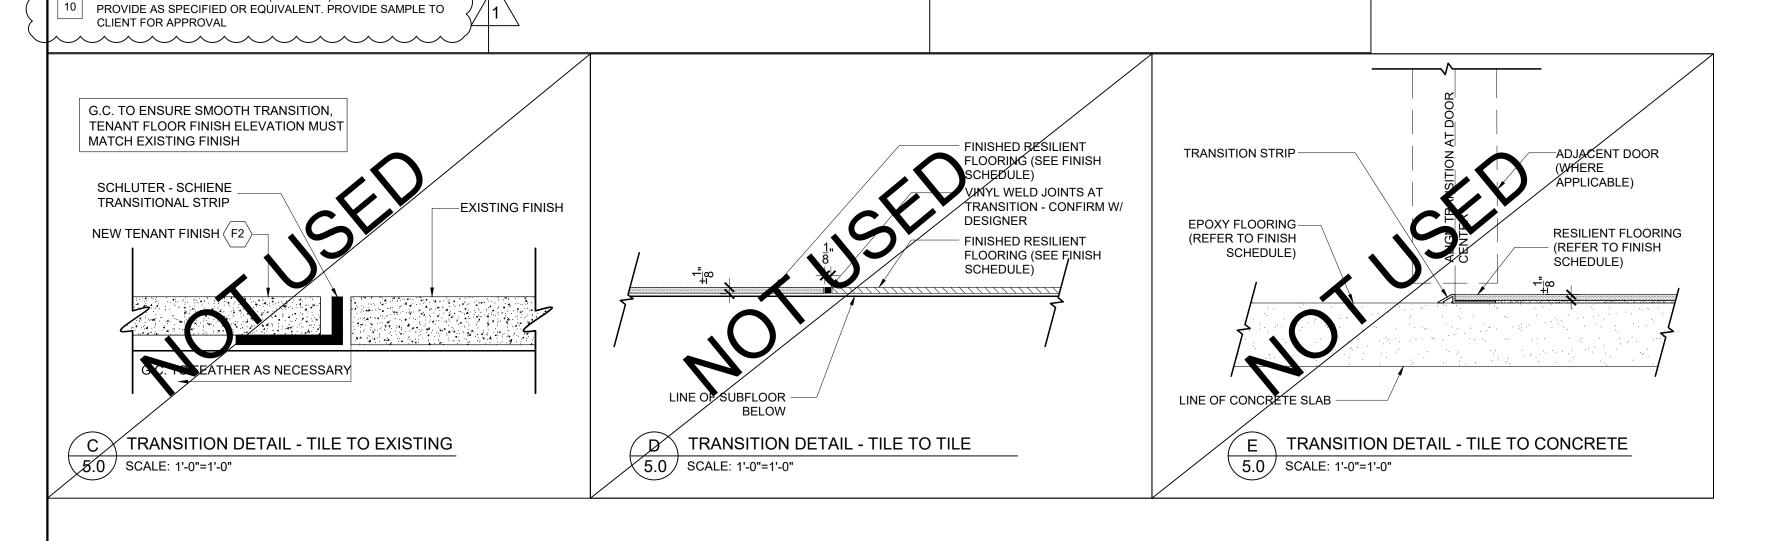

	FINI	ISH LEGEN	ND			ISSUE	
	NO.	MATERIAL	DESCRIPTION	LOCATION	REMARKS		
LES	(PL1)	PLASTIC LAMINATE (BLACK)	FORMICA 909 BLACK	INTERIOR MILLWORK CONSTRUCTION			
LAMINATES	PL2	COLOUB THRU LAMINATE (WHITE)	MEVAMAR MELCOR I/NM55S-7024E CHALK WHITE	PLATFORMS	ADRIAN BECK PANOLAM INDUSTRIES 416-978-4912 ADRIAN BECK@PANOLAM.COM	4. MAY 18, 2023	ISSUED FOR TEND
	(PT1)	PAINT (STORE INTERIOR)	BENJAMIN MOORE, WHITE HERON OC-57, LATEX PAINT, PEARL FINISH	SALES AREA, WASHROOM		3. MAY 17, 2023 2. MAY 4, 2023	ISSUED FOR PERM
PAINT	PT2	PAINT (STORE CEILING)	BENJAMIN MOORE, BLACK INK, 2127-20, LATEX PAINT, FLAT FINISH	STOREFRONT CEILING	AURA LINE	1. APRIL 25, 2023	ISSUED FOR CLIEN
	<b>РТ3</b>	PAINT GREY	BENJAMIN MOORE, KENDALL CHARCOAL HC-166 PEARL FINISH	BOH (TATTOO STNS) WALLS / SEMI TRIM		# Date PROJECT TITL	Description .E:
	F1	TIKE (PØRCELAIN)					STEE
FLOORING	F2	TILE (PORCELAIN)	OLYMPIA TILE - DESIGN INDUSTRY - OXYDE DARK RF.DI.ODK.1224 12"X24" GROUT BY FLEXTILE, CHARCOAL	GENERAL THROUGHOUT	CONTACT: OLYMPIA TILE DEANNA MALONEY PH: 416-785-9555 ext 395		INK
=	vet	VINYL COMPOSITE	ARMSTRONG, 12" x 12", 51908-PEWTER	WASHROOM			
	VB1	VINYL BASE	JOHNSON 4" COVE VINYL BASE - WHITE	WASHROOM		161	ONAN C 5 REGEN
MILL- WORK	ML1	MELAMINE (WHITE)	3" THK WHITE MELAMINE	INTERIOR MILLWORK FINISH		\	WINNIPEC R2C 50
	M <sub>1</sub>	POLISHED ALUMINUM	TBD			REVISION	CRU #
LAL LA	M2	POLISHED CHROME	1/2" POLISHED CHROME	FLOOR FIXTURES		REVISION	
METAL	M3	WHITE POWDER	TO MATICH PTA	FLOOR FIXTURES & STOREFRONT			
	M4)	MATTE BLACK METAL	ALPOLIC METAL COMPOSITE BLX BLACK	STOREFRONT			
CEILING	(ACT)	CEILING TILE	BLACK - CEILUME CENTURY CEILING TILE 2X2	BOH (TATTOO STNS)	T'S BLACK FINISH		
	(MR1)	MIRROR	1/4" CLEAR MIRROR	MILLWORK		1 MAY 17, 2023 # Date	REV TO VANITY A
	(GL1)	TEMPERED GLASS (CLEAR)	CLEAR TEMPERED GLASS			DRAWING TITI	•
MISC.	FB1	FABRIC	BLACK VINYL (FAUX LEATHER)			ſ	FINISHES I
MIS	FRP	STANDARD F.R.P.	F.R.P. PANEL BY MARCITE MODEL NO. S-100 "WHITE" FINISH: SMOOTH	FROM BASE TO 48" AFF (LOWER PORTION OF WALL IN STOCKROOM)	APPROPRIATE WHITE TRIM AT TOP OF PANEL AS REQUIRED (PANEL SIZE: 4'x 8') CONTACT: GREG LEARY		

OLYMPIA TILE - CITY SERIES - LIGHT GREY

(3" X 12") UD.CT.LGR.0312.MT

GROUT BY FLEXTILE, SNOW WHITE

TILE TL1 TILE (PORCELAIN)



Suite 800 Toronto, ON. M2N 6K8 T.416.497.3662 info@glsmith.ca www.glsmith.ca

G.L. SMITH

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MAY 18, 2023 ISSUED FOR TENDER MAY 17, 2023 ISSUED FOR PERMIT MAY 4, 2023 ISSUED FOR L.LORD REVIEW APRIL 25, 2023 ISSUED FOR CLIENT REVIEW

> STEEL  $\mathbb{N}$ INK

KILDONAN CROSSING 1615 REGENT AVE W WINNIPEG, MB R2C 5C6 CRU # 4

/303-260-7630

DEANNA MALONEY PH:

416-785-9555 ext 395 SEE DWG 5.0 FOR REF

SALES AREA HALF WALL

MAY 17, 2023 REV TO VANITY AND STORAGE DETAILS BS Description AWING TITLE:

FINISHES PLAN

RINT DATE:	SCALE:
17-May-23	AS NOTE
RAWN BY:	DRAWING NO:
BS	_
HECKED BY:	

GENERAL LEGEND					
102	ROOM NUMBER (REFER TO ARCHITECTURAL DRAWINGS)	1	NOTE BUBBLE INDICATING THAT A DRAWING NOTE APPLIES. REFER TO NOTES		
<u></u>	REVISION BUBBLE	1 M-01	DETAIL NUMBER DRAWING NUMBER		

	FIRE PROTEC	CTION L	EGEND
<b>⊙</b> <sup>N</sup>	NEW CONCEALED SPRINKLER HEAD	O EX	EXISTING UPRIGHT SPRINKLER HEAD TO REMAIN
<b>▼</b> N	NEW SIDEWALL SPRINKLER HEAD	⊚ <sup>EX</sup>	EXISTING CONCEALED TYPE SPRINKLER HEAD TO REMAIN
● <sup>N</sup>	NEW DRY PENDANT SPRINKLER HEAD	∑EX	EXISTING SIDE WALL TYPE SPRINKLER HEAD TO REMAIN
ON	NEW UPRIGHT SPRINKLER HEAD	● <sup>EX</sup>	EXISTING PENDANT TYPE SPRINKLER HEAD
<b>⊗</b> FEA	NEW FIRE EXTINGUISHER ASSEMBLY	SEX SEX SEX SEX SEX	EXISTING SPRINKLER HEADS TO BE REMOVED
EX FEA	EXISTING FIRE EXTINGUISHER ASSEMBLY		FIRE HOSE CABINET

—SAN— — -	SANITARY BELOW GRADE/FLOOR	CTE	CONNECT TO EXISTING
— SAN—	SANITARY ABOVE GRADE/FLOOR	<u> </u>	REDUCER/INCREASER
— -ST— — —	- STORM BELOW GRADE/FLOOR	———	UNION
ST	STORM ABOVE GRADE/FLOOR	<b>_</b>	BALL VALVE
—GRS —	GREASE SUCTION LINE	<b>─</b> ⋈─	GATE VALVE/SHUT-OFF VALVE
—GW — —	GREASE WASTE LINE	_ <del>\</del>	CHECK VALVE
— DCW —	DOMESTIC COLD WATER	<u>-</u> 27	DOUBLE CHECK VALVE ASSEMBLY
—— DHW ——	DOMESTIC HOT WATER		DUAL CHECK VALVE
110	DOMESTIC HOT WATER @110° F		REDUCED PRESSURE B.F.P.
——DHWR—	HOT WATER RECIRCULATION LINE	— G —	GAS PIPING
—— FW———	FILTERED COLD WATER LINE	₩H <b>→</b> × <b> </b>	WALL HYDRANT / HOSE BIB
<del></del>	PIPE DOWN	<b>—</b>	TEE FITTING
<b>○</b>	PIPE UP	CO   <del> </del>	LINE CLEANOUT
<b>●</b> RD	ROOF DRAIN	COO-	FLOOR CLEANOUT
<del></del>	ELECTRIC HEAT TRACING	A	PRV VALVE
HD HD	HUB DRAIN	M	THERMOSTAT MIXING VALVE
FD -	FLOOR DRAIN	[WM]	WATER METER
FD ⊖	FUNNEL FLOOR DRAIN	—[GM]—	GAS METER
P	TRAP PRIMER	[000]	FILTRATION SYSTEM
	PIPING SERVICE CONTINUES		CIRCULATION PUMP
<del></del>	REFER TO STANDARD DETAIL DRAWINGS FOR ADDITIONAL REQUIREMENT OF EQUIPMENT NOTED	?	

	HVAC LE	GEND	
	SQUARE SUPPLY AIR DUCT UP	VD	VOLUME DAMPER
_><<_	SQUARE SUPPLY AIR DUCT DOWN	BDD -	BACK DRAFT DAMPER
	SQUARE RETURN OR EXHAUST AIR DUCT UP	SD	SPLITTER DAMPER
	SQUARE RETURN OR EXHAUST AIR DUCT DOWN	—— <b>√</b> FD	FIRE DAMPER
	ROUND RETURN OR EXHAUST AIR DUCT UP	—— FF	FIRE FLAP
0	ROUND RETURN OR EXHAUST AIR DUCT DOWN	САР	CAPPED CONNECTION
}	EXISTING DUCT TO REMAIN	U/C	UNDER CUT DOOR 19mm
	EXISTING DUCT TO BE REMOVED		DUCT BREAK - DUCT CONTINUES
	ACOUSTIC LINED DUCT		UNIT HEATER
	INSULATED DUCT		ACOUSTICALLY LINED TRANSFER
~~~	FLEXIBLE DUCT	<u> </u>	AIR DUCT
~~~	EXISTING FLEXIBLE DUCT	CFM	EXISTING DIFFUSER RE-BALANCE AIR QUANTITY
	RIGID ROUND DUCT	T	ELECTRIC THERMOSTAT TO REMAIN
	EXISTING RIGID ROUND DUCT	<i>(\$)</i> ,	ELECTRIC THERMOSTAT TO BE REMOVED
<b>1</b>	DUCT OF FAM OUT	S	TEMPERATURE SENSOR
	DUCT CLEAN OUT	(CO <sub>2</sub> )	C02 SENSOR
#	FLEX CONNECTION	<u> </u>	MOTORIZED CONTROL DAMPER
KKK	ELBOW WITH TURNING VANES	T	EXISTING ELECTRIC THERMOSTAT
		H	HUMIDISTAT
$\longrightarrow$	WALL/DUCT SUPPLY REGISTER		DUCT HEATING COIL
	BAFFLE ONE SIDE OF DIFFUSER		LINEAR DIFFUSER
	BAFFLE/BLANK DIFFUSER BLANK OFF		RETURN/EXHAUST GRILLE
	ROUND DIFFUSER	A B	RETURN AIR A. TYPE GRILLES/REGISTER B. SIZE OF GRILLES/REGISTERS
A Bø C	SUPPLY AIR A. TYPE OF DIFFUSER B. SIZE OF DIFFUSER & NECK C. INDICATES CAPACITY FOR EACH		

	DRAWING LIST
DRAWING NO.	DRAWING NAME
M1.0	DRAWING LIST AND MECHANICAL LEGENDS
M2.0	DETAILS
M3.0	PLUMBING PLAN AND NOTES
M3.1	SANITARY PLAN AND NOTES
M4.0	HVAC PLAN AND NOTES
M5.0	SCHEDULES
M6.0	SPECIFICATIONS
M6.1	SPECIFICATIONS
M6.2	SPECIFICATIONS

	ABBREV	.,	ADOVE TO USE TO SEE
ABC	ALBERTA BUILDING CODE	AFF	ABOVE FINISHED FLOOR
ANSI	AMERICAN NATIONAL STANDARDS INSTITUTE	ARI	AIR-CONDITIONING AND REFRIGERATION INSTITUTE
AHRI	AIR-CONDITIONING, HEATING AND REFRIGERATION INSTITUTE	ASHRAE	AMERICAN SOCIETY OF HEATING REFRIGERATING AND AIR CONDITIONING ENGINEERS
ASME	AMERICAN SOCIETY OF MECHANICAL ENGINEERS	ASTM	ASTM INTERNATIONAL (FORMERLY AMERICAN SOCIETY FOR TESTING AND MATERIALS)
ВНР	BOILER HORSEPOWER OR BRAKE HORSEPOWER	Btu/hr	BRITISH THERMAL UNITS PER HOUR
CFM	CUBIC FEET PER MINUTE	CSA	CANADIAN STANDARDS ASSOCIATION
CTE	CONNECT TO EXISTING	CSA	CANADIAN STANDARDS ASSOCIATION
cu.ft.	CUBIC FEET	cu.m.	CUBIC METER
db	DRY BULB	DDC	DIRECT DIGITAL CONTROL
dia.	DIAMETER	EF	EXHAUST FAN
FFH	FAN FORCED HEATER	FHC	FIREHOSE CABINET
F.L.A.	FULL LOAD AMPS	ft.	FOOT OR FEET
gal	GALLONS	GPM	GALLONS PER MINUTE
hp	MOTOR HORSEPOWER	in.	INCH OR INCHES
kg	KILOGRAM	kPa	KILOPASCALS
kW	KILOWATTS	L	LITRE
L/s	LITRES PER SECOND	МВН	1000 BRITISH THERMAL UNITS PER HOUR
mm	MILLIMETRE	m	METRE
NPT	AMERICAN NATIONAL STANDARD TAPER PIPE THREAD	OAT	OUTSIDE AIR TEMPERATURE
OBC	ONTARIO BUILDING CODE	ppm	PART PER MILLION
psi	POUNDS PER SQUARE INCH	psig	POUNDS PER SQUARE INCH GAUGE
PVC	POLYVINYL CHLORIDE	REL	RELOCATE
RH	RELATIVE HUMIDITY	rpm	REVOLUTIONS PER MINUTE
sp. in. wg.	STATIC PRESSURE, INCHES WATER GAUGE	SF	SUPPLY FAN
TDS	TOTALLY DISSOLVED SOLIDS	ULC	UNDERWRITER'S LABORATORIES OF CANADA
VFD	VARIABLE FREQUENCY DRIVE	W	WATT
W/ft.	WATTS PER FOOT	WC	WATER CLOSET
wb	WET BULB		



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	T		
4	2023-05-18	ISSUED FOR TENDER	TW
3	2023-05-17	ISSUED FOR PERMIT	TW
2	2023-05-04	ISSUED FOR LLORD REVIEW	TW
1	2023-04-25	ISSUED FOR CLIENT REVIEW	TW

PROJECT TITLE:

# Date Description



KILDONAN CROSSING 1616 REGENT AVE W WINNIPEG, MB R2C 5C6 CRU # 4


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# Date Description DRAWING TITLE:

DRAWING LIST & MECHANICAL LEGENDS

PRINT DATE: 2023-05-18 AS NOTED DRAWING NO: DRAWN BY: TW CHECKED BY:

PROJECT NO:

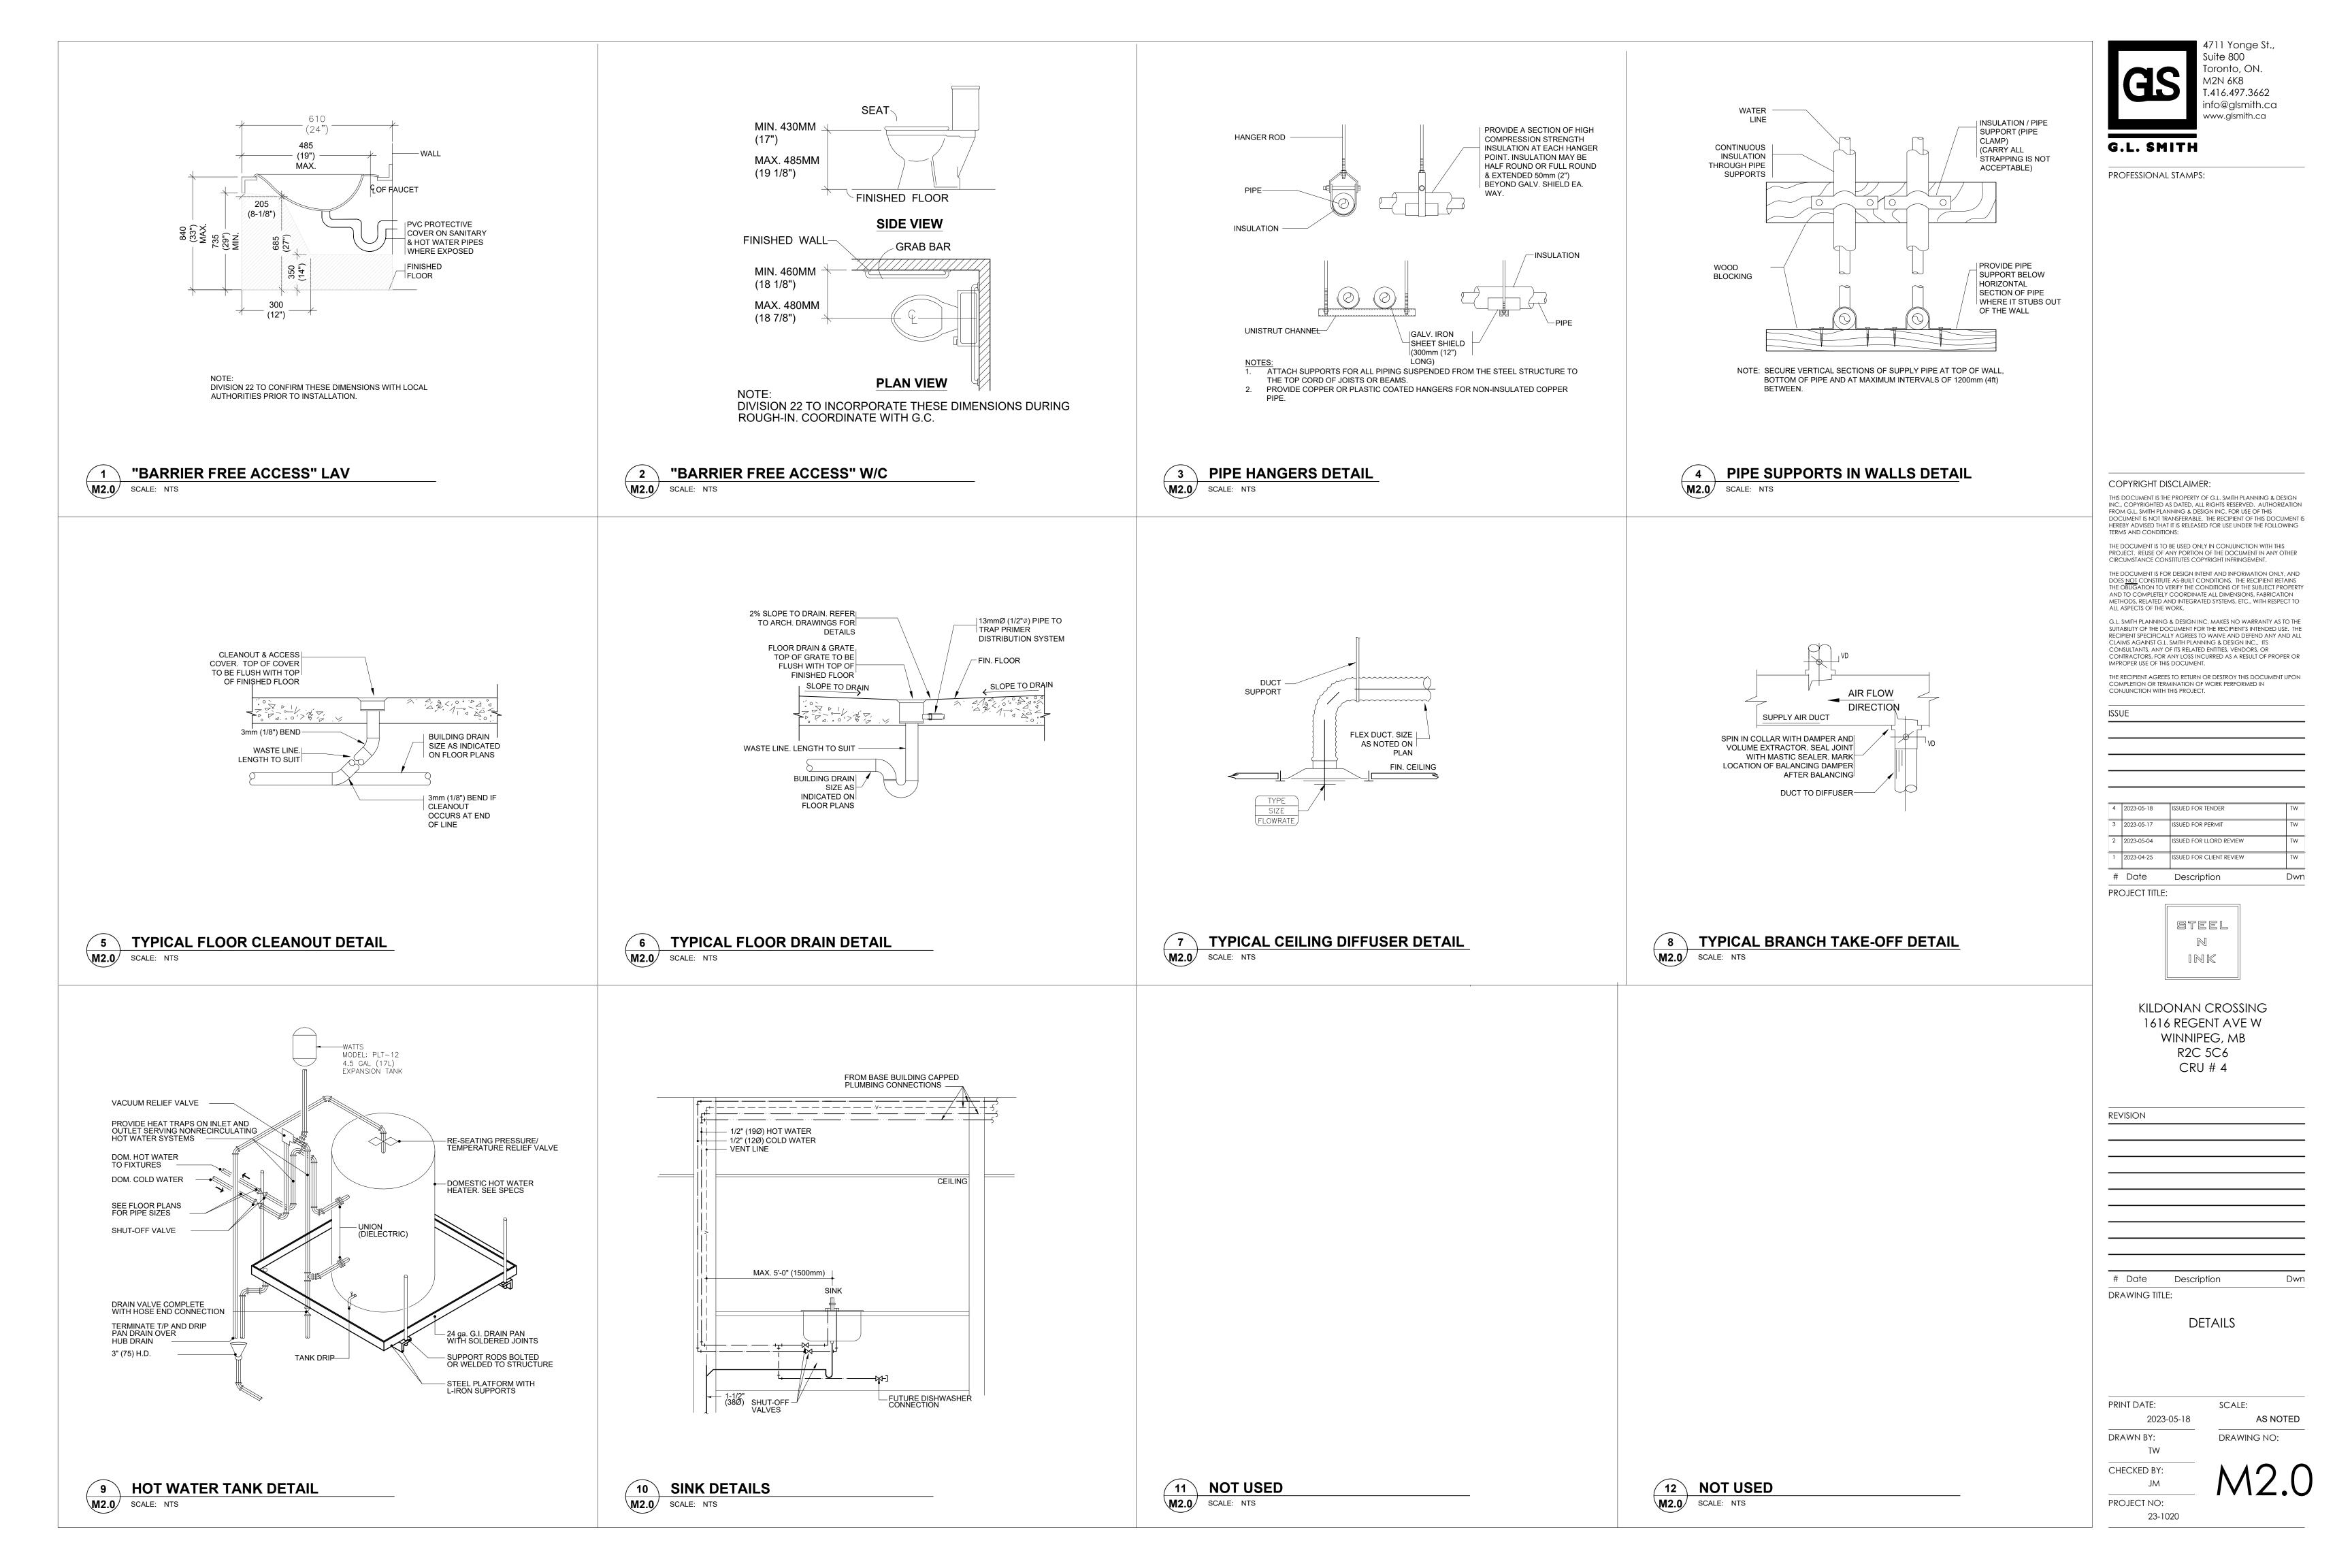

## PLUMBING NOTED DEVICES

- CONNECT NEW 1"Ø DOMESTIC COLD WATER LINE TO EXISTING WATER LINE OF ADEQUATE SIZE ABOVE WASHROOM AND EXTEND AS INDICATED ON DRAWING.
- SUPPLY AND INSTALL NEW SINK, PROVIDE NEW 1/2"Ø DOMESTIC HOT AND COLD WATER LINES DOWN IN WALL TO SERVE SINK. REFER TO DETAIL 10/M2.0.
- SUPPLY AND INSTALL NEW HOT WATER TANK IN CEILING SPACE COMPLETE WITH ALL ASSOCIATE APPURTENANCES; HANGARS, SUPPORTS, DRIP TRAY, PLUMBING LINES ETC. REFER TO DETAILS #5 M2.0 PROVIDE NEW 3/4"Ø DOMESTIC COLD WATER LINE TO HOT WATER TANK AND NEW 3/4"Ø DOMESTIC HOT WATER LINE EXTENDED FROM HOT WATER TANK. INSTALL AS PER MANUFACTURER RECOMMENDATIONS.
- SUPPLY AND INSTALL NEW LAVATORY, PROVIDE NEW 1/2"Ø DOMESTIC HOT AND COLD WATER LINES DOWN IN WALL TO SERVE NEW LAVATORY.
- SUPPLY AND INSTALL NEW WATER CLOSET, PROVIDE NEW 1/2"Ø DOMESTIC COLD WATER LINES DOWN IN WALL TO SERVE NEW WATER CLOSET.
- 6. SUPPLY AND INSTALL NEW MOP SINK, PROVIDE NEW 1/2"Ø DOMESTIC HOT AND COLD WATER LINES DOWN IN WALL TO SERVE SINK.
- EXISTING WALL MOUNTED FIRE EXTINGUISHER TO BE RELOCATED TO PROPOSED LOCATION AS INDICATED, PROVIDE TO WALL MOUNT BRACKETS AS REQUIRED.

# **PLUMBING NOTES**

- A. SUPPLY AND INSTALL PLUMBING FIXTURES WHERE SHOWN. FOR EXACT LOCATION OF FIXTURES REFER TO ARCHITECTURAL DRAWINGS. PROVIDE SCREW DRIVER STOPS ON EACH FIXTURE SUPPLY. VISIBLE PARTS OF FIXTURE TRIM TO BE HEAVILY CHROME-PLATED.
- B. SUPPLY AND INSTALL DRAINAGE SYSTEM, CLEANOUTS, TRAPS, FITTINGS AND VENTING IN

ACCORDANCE WITH PLUMBING CODE AND LOCAL MUNICIPAL REGULATIONS.

- C. SIZES AND MATERIALS OF PLUMBING PIPES AND DRAINS TO BE IN ACCORDANCE WITH PLUMBING CODE AND AUTHORITIES HAVING JURISDICTION.
- D. BURIED SANITARY DRAIN: P.V.C., SDR-35, OR VITRIFIED TILE.
- E. ABOVE GROUND WASTE AND VENT STACKS SHALL BE P.V.C. DWV PLASTIC PIPING FOR SINGLE-STOREY BUILDINGS AND 'DWV' COPPER PIPING WITH WROUGHT COPPER SOLDER JOINTS FOR MULTI-STOREY BUILDINGS.
- F. DOMESTIC COLD AND HOT WATER PIPING: STANDARD TYPE 'L' COPPER. SOLDER JOINTS WITH 95/5 SOLDER, LEAD FREE.
- G. COVER DOMESTIC COLD AND HOT WATER PIPING WITH FIBRE-GLASS STANDARD PIPE INSULATION WITH FACTORY APPLIED FLAME RETARDANT DUAL TEMPERATURE BARRIER JACKET. INSULATION THICKNESS SHALL BE FOLLOWS: - RUNOUTS UP TO 2" (12' MAX. LENGTH) USE 1/2" INSULATION - 1/2" UP TO 4° PIPE USE 1" INSULATION,
- H. POTABLE WATER PIPING TO BE FLUSHED AND STERILIZED ON COMPLETION OF WORK.
- SUPPLY AND INSTALL BACK FLOW PREVENTOR IF REQUIRED BY LOCAL CODES AND/OR AUTHORITIES.
- J. ALL DOMESTIC HOT AND COLD WATER LINES TO BE MINIMUM 3/4"Ø UNLESS INDICATED OTHERWISE.



Toronto, ON. M2N 6K8 T.416.497.3662 info@glsmith.ca www.glsmith.ca

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# Date Description PROJECT TITLE:

REVISION

STEEL INK

KILDONAN CROSSING 1616 REGENT AVE W WINNIPEG, MB R2C 5C6 CRU # 4


ate Description Dwn

PLUMBING PLAN & NOTES

PRINT DATE: SCALE: 2023-05-18 AS NOTED DRAWING NO: DRAWN BY:

TW CHECKED BY:

DRAWING TITLE:

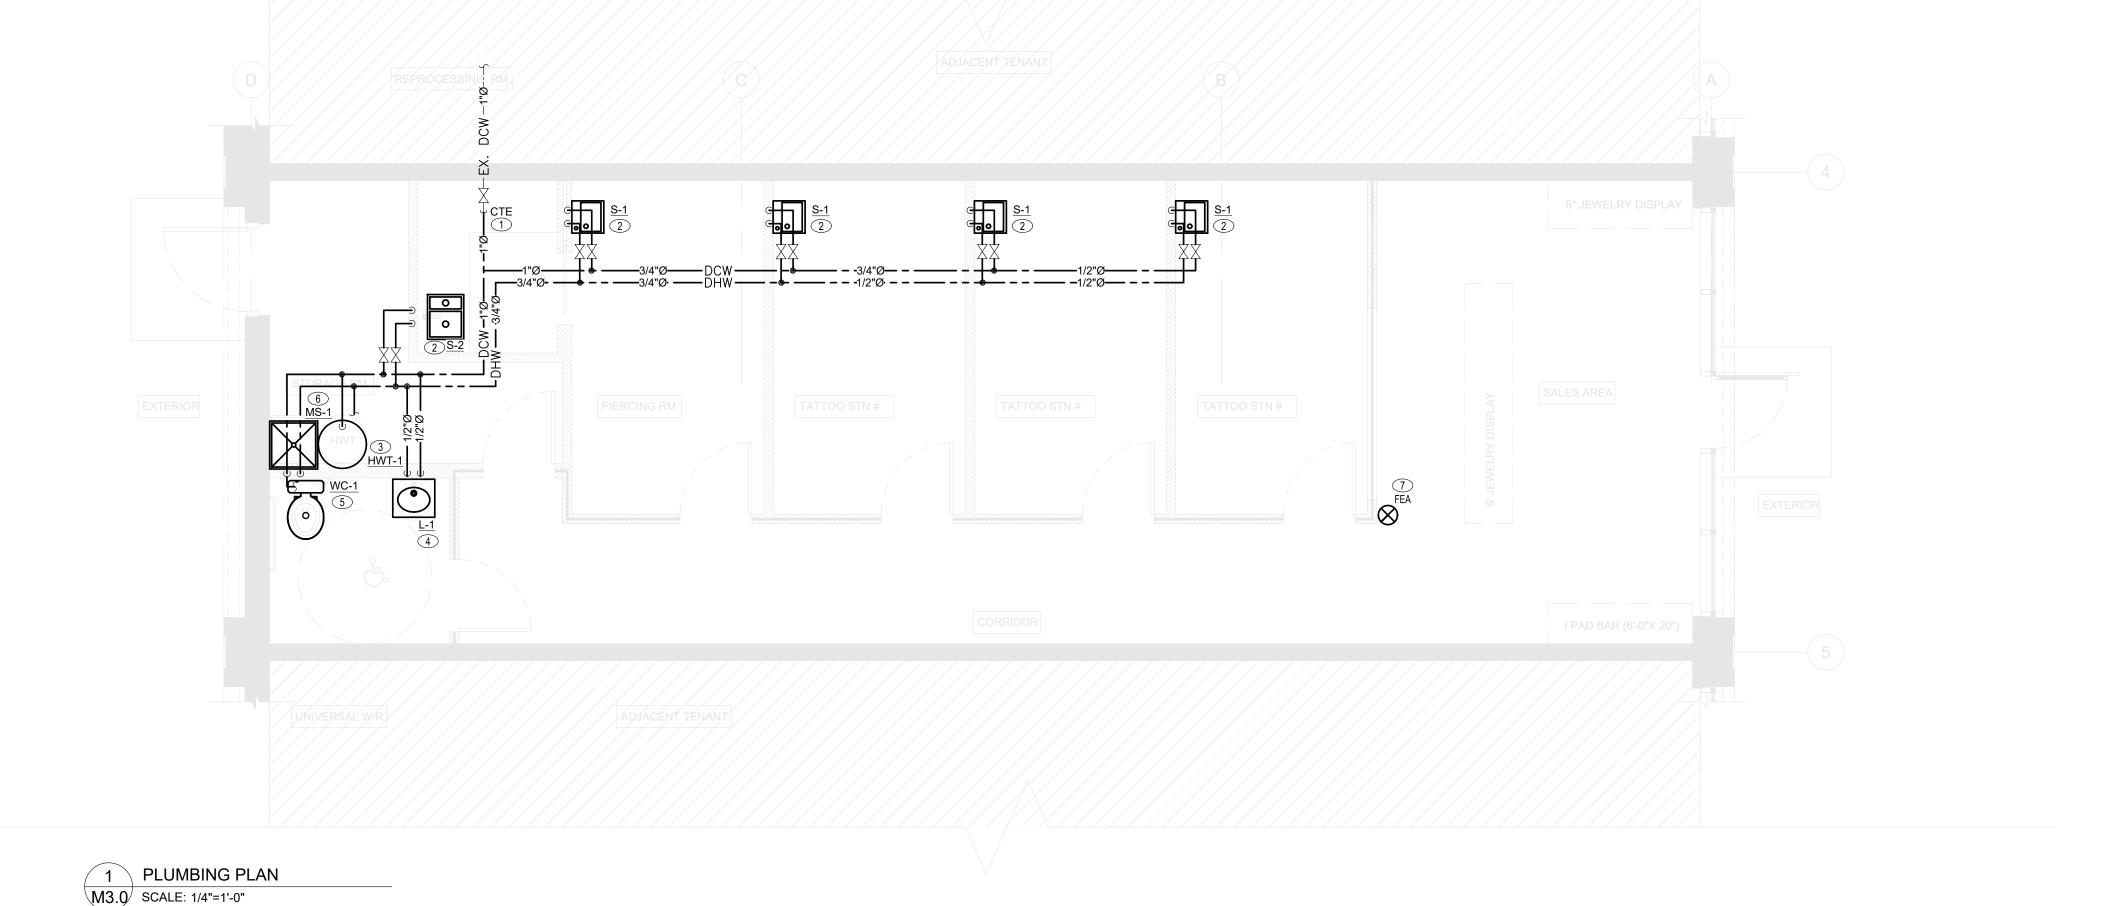

## SANITARY NOTED DEVICES

- 1. TIE-IN NEW SANITARY LINE TO EXISTING 6"Ø SANITARY MAIN ON SITE. VERIFY EXACT LOCATION OF EXISTING LINE ON SITE.
- 2. TIE-IN NEW SANITARY LINE TO EXISTING 4"Ø SANITARY LINE ON SITE. VERIFY EXACT LOCATION OF EXISTING LINE ON SITE.
- 3. SUPPLY AND INSTALL NEW SINK <u>S-1</u>, PROVIDE NEW 1-1/2"Ø SANITARY DRAIN FROM SINK DOWN IN FURRED OUT WALL TO BELOW GRADE. 1-1/2"Ø VENT LINE UP TO CEILING SPACE.
- 4. SUPPLY AND INSTALL NEW SINK <u>S-2</u>, PROVIDE NEW 1-1/2"Ø SANITARY DRAIN FROM SINK DOWN IN FURRED OUT WALL TO BELOW GRADE. 1-1/2"Ø VENT LINE UP TO CEILING SPACE.
- 5. SUPPLY AND INSTALL NEW MOP SINK MS-1, PROVIDE NEW 3"Ø SANITARY DRAIN FROM SINK DOWN IN FURRED OUT WALL TO BELOW GRADE. 2-1/2"Ø VENT LINE UP TO CEILING SPACE.
- 6. SUPPLY AND INSTALL NEW LAVATORY <u>L-1</u>, PROVIDE NEW 1-1/2"Ø SANITARY DRAIN FROM LAVATORY DOWN IN FURRED OUT WALL TO BELOW GRADE. 1-1/4"Ø VENT LINE UP TO CEILING SPACE.
- 7. SUPPLY AND INSTALL NEW WATER CLOSET <u>WC-1</u>, PROVIDE NEW 3"Ø SANITARY DRAIN FROM LAVATORY DOWN IN FURRED OUT WALL TO BELOW GRADE. 2"Ø VENT LINE UP TO CEILING SPACE.
- 8. NEW HOT WATER TANK IN CEILING SPACE DISCHARGE DRIP PAN AND PRESSURE RELIEF OVER NEW HUB DRAIN IN CEILING SPACE TIE HUB DRAIN INTO TAIL STOCK OF NEW SINK. REFER TO DETAILS 9/M2.0 AND 10/M2.0. HUB DRAIN IN CEILING SPACE TO BE TRAPPED AND PRIMED.
- 9. NEW VENT LINE TO SERVE THE NEW PLUMBING FIXTURE. CONNECT NEW VENT LINES TO EXISTING 3"Ø VENT LINE IN CEILING SPACE. VERIFY EXACT LOCATION ON SITE. PROVIDE A COMPLETE AND OPERATION VENTING SYSTEM AS PER OBC AND LOCAL AUTHORITIES HAVING JURISDICTION.

A. SUPPLY AND INSTALL PLUMBING FIXTURES WHERE SHOWN. FOR EXACT LOCATION OF FIXTURES REFER TO ARCHITECTURAL DRAWINGS. PROVIDE SCREW DRIVER STOPS ON EACH FIXTURE SUPPLY. VISIBLE PARTS OF FIXTURE TRIM TO BE HEAVILY CHROME-PLATED.

SANITARY NOTES

B. SUPPLY AND INSTALL DRAINAGE SYSTEM, CLEANOUTS, TRAPS, FITTINGS AND VENTING IN

ACCORDANCE WITH PLUMBING CODE AND LOCAL MUNICIPAL REGULATIONS.

- C. SIZES AND MATERIALS OF PLUMBING PIPES AND DRAINS TO BE IN ACCORDANCE WITH PLUMBING CODE AND AUTHORITIES HAVING JURISDICTION.
- D. BURIED SANITARY DRAIN: P.V.C., SDR-35, OR VITRIFIED TILE.

- 1/2" UP TO 4° PIPE USE 1" INSULATION,

- E. ABOVE GROUND WASTE AND VENT STACKS SHALL BE P.V.C. DWV PLASTIC PIPING FOR SINGLE-STOREY BUILDINGS AND 'DWV' COPPER PIPING WITH WROUGHT COPPER SOLDER JOINTS FOR MULTI-STOREY BUILDINGS.
- F. DOMESTIC COLD AND HOT WATER PIPING: STANDARD TYPE 'L' COPPER. SOLDER JOINTS WITH 95/5 SOLDER, LEAD FREE.
- G. COVER DOMESTIC COLD AND HOT WATER PIPING WITH FIBRE-GLASS STANDARD PIPE INSULATION WITH FACTORY APPLIED FLAME RETARDANT DUAL TEMPERATURE BARRIER JACKET. INSULATION THICKNESS SHALL BE FOLLOWS:
   RUNOUTS UP TO 2" (12' MAX. LENGTH) USE 1/2" INSULATION
- H. POTABLE WATER PIPING TO BE FLUSHED AND STERILIZED ON COMPLETION OF WORK.
- SUPPLY AND INSTALL BACK FLOW PREVENTOR IF REQUIRED BY LOCAL CODES AND/OR AUTHORITIES.
- J. ALL DOMESTIC HOT AND COLD WATER LINES TO BE MINIMUM 3/4"Ø UNLESS INDICATED OTHERWISE.



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1	2023-04-25	ISSUED FOR CLIENT REVIEW	TW
#	Date	Description	Dw

PROJECT TITLE:

REVISION

STEEL N INK

KILDONAN CROSSING 1616 REGENT AVE W WINNIPEG, MB R2C 5C6 CRU # 4

# Date	Description	Dwn

# Date Description Dwr DRAWING TITLE:

> Sanitary plan & notes


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2023-05-18
DRAWN BY: DRAWING NO:

CHECKED BY:

23-1020

PROJECT NO:

M3.1

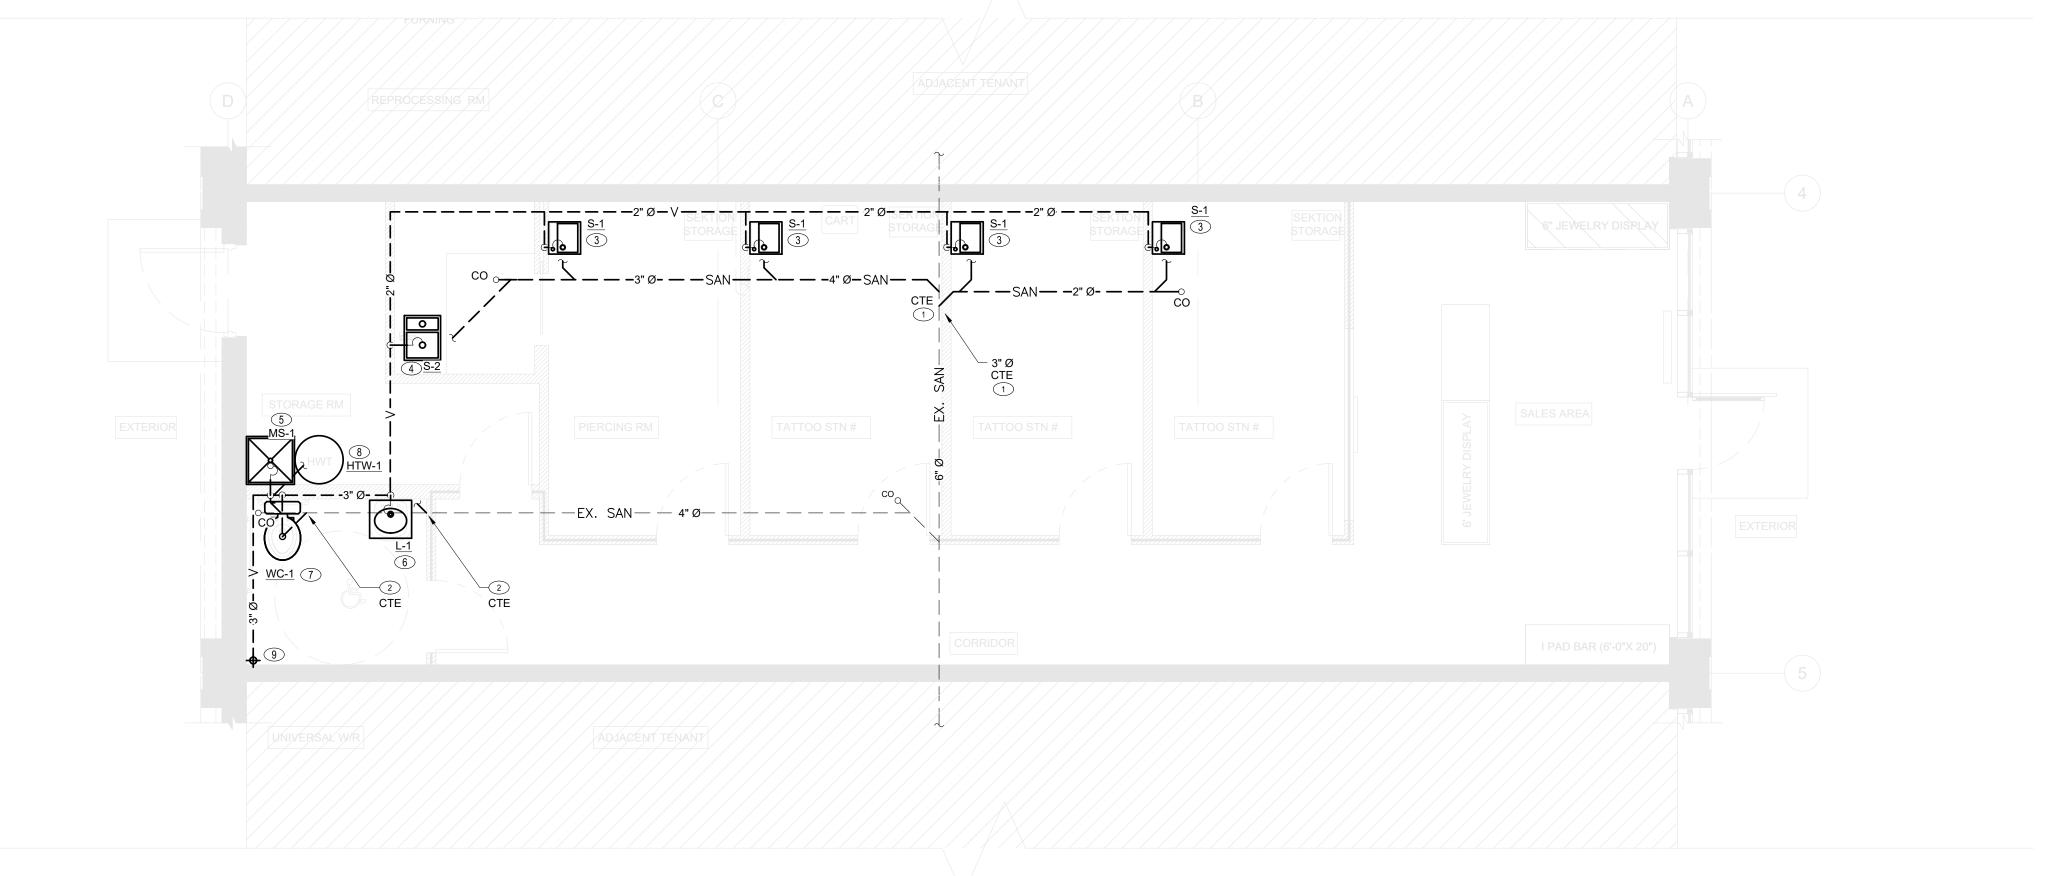

1 SANITARY PLAN

M3.1 SCALE: 1/4"=1'-0"

## **HVAC NOTES**

- 1. NEW 7 DAY PROGRAMMABLE THERMOSTAT AT THIS PROPOSED LOCATION COMPLETE WITH LOCKABLE COVER, EXTEND CONTROL WIRING AS REQUIRED. INSTALL THERMOSTAT AT 48" A.F.F.
- 2. SUPPLY AND INSTALL NEW DIFFUSER AS INDICATED ON DRAWINGS, DUCT RUN-OUT SIZE TO MATCH DIFFUSER INLET. PROVIDE NEW FLEXIBLE DUCT FROM SUPPLY AIR DUCTWORK OR EXTEND RIGID AS REQUIRED, MAXIMUM LENGTH OF FLEXIBLE DUCTWORK NOT TO EXCEED 8'-0".
- 3. SUPPLY AND INSTALL NEW RETURN AIR GRILLE AS INDICATED ON DRAWINGS.
- 4. SUPPLY AND INSTALL NEW ACOUSTICALLY LINED RETURN AIR ELBOW. RETURN ELBOW TO MATCH RETURN AIR OPENING, CONTRACTOR TO VERIFY EXACT SIZE OF UNIT OPENINGS ON SITE PRIOR TO MANUFACTURING NEW DUCT WORK.
- NEW SUPPLY DUCTWORK TO BE ACOUSTICALLY LINED FOR THE FIRST 15'. NEW TO MATCH SUPPLY AIR OPENING, CONTRACTOR TO VERIFY EXACT SIZE OF UNIT OPENINGS ON SITE PRIOR TO MANUFACTURING NEW DUCT WORK. G.C. TO CONFIRM EXISTING IF ANY.
- 6. EXISTING ROOF TOP UNITS TO REMAIN
- 7. PROVIDE DUCT COLLAR AT WALL PENETRATION. (TYPICAL)
- 8. SUPPLY AND INSTALL EXHAUST FAN IN CEILING SPACE COMPLETE WITH HANGERS, SUPPORTS, FLEX CONNECTIONS, DUCTWORK, CONTROLS/CONTROL WIRING, ETC. INTERLOCK FAN WITH OCCUPANCY SENSOR FOR WASHROOM TIME DELAY TO OFF MINIMUM 15 MIN. EXTEND 6"Ø EXHAUST DUCT AND TERMINATE UP THRU ROOF WITH GOOSENECK, OUTLET TO BE MINIMUM 10'-0" FROM ANY FRESH AIR INTAKES OR BUILDING OPENINGS. WIRED BY ELECTRICAL DIVISION. FIELD VERIFY ON SITE.
- 9. 1"Ø DOOR UNDER CUT.
- 10. 18" x 6" RETURN AIR GRILLE CONNECTED TO 18" x 6" TRANSFER AIR DUCT AND DISCHARGE TO CEILING SPACE.
- 11. NEW BASEBOARD HEATERS <u>BBH-1</u>, <u>BBH-2</u> AND <u>BBH-3</u>. SUPPLIED AND INSTALLED BY ELECTRICAL DIVISION. REFER TO ELECTRICAL DRAWING FOR SPEC. (TYPICAL)
- 11. NEW FAN FORCED HEATERS <u>FFH-1</u> AND <u>FFH-2</u>. SUPPLIED AND INSTALLED BY ELECTRICAL DIVISION. REFER TO ELECTRICAL DRAWING FOR SPEC. (TYPICAL)

## **HVAC NOTES**

- A. ALL 90° SUPPLY & RETURN ELBOWS SHALL HAVE SMOOTH RADIUSES. SQUARE ELBOWS SHALL BE COMPLETE WITH TURNING VANES.
- B. UNLESS NOTES OTHERWISE, MEASUREMENTS ARE IN IMPERIAL UNITS, SUCH AS CUBIC FEET PER MINUTE (AIR FLOW) AND INCHES (DISTANCE).
- C. FOR VENTS AND DUCTWORK PASSING THROUGH FIRE RATED ASSEMBLY, DIVISION 23 SHALL PROVIDE APPROPRIATE FIRE CLOSURE(S) SUCH AS DAMPERS, CAULKING, AND FIRE DONUTS. ALL FIRE CLOSURE RATINGS SHALL MATCH THE RATING OF THE FIRE RATED ASSEMBLIES THROUGH WHICH THEY ARE DESIGNED TO PASS THROUGH.
- D. ALL THERMOSTATS SHALL BE SITUATED AT A HEIGHT OF 1.2m (4') AFF, AT THE LOCATION SPECIFIED ON PLAN. COORDINATION BETWEEN THE PROFESSIONS IS RECOMMENDED TO AVOID ANY POSSIBLE OBSTRUCTIONS.
- E. EXISTING HEAT PUMP TO REMAIN. PROFESSIONALLY CLEAN DUCTWORK. REPAIR IF NECESSARY.



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# Date Description
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REVISION

STEEL N INK

KILDONAN CROSSING 1616 REGENT AVE W WINNIPEG, MB R2C 5C6 CRU # 4

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2 A WINIC	3 TITLE:	

HVAC PLAN & NOTES

PRINT DATE: SCALE:

2023-05-18

DRAWN BY: DRAWIN

TW


DRAWING NO:

AS NOTED

PROJECT NO: 23-1020

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CHECKED BY:

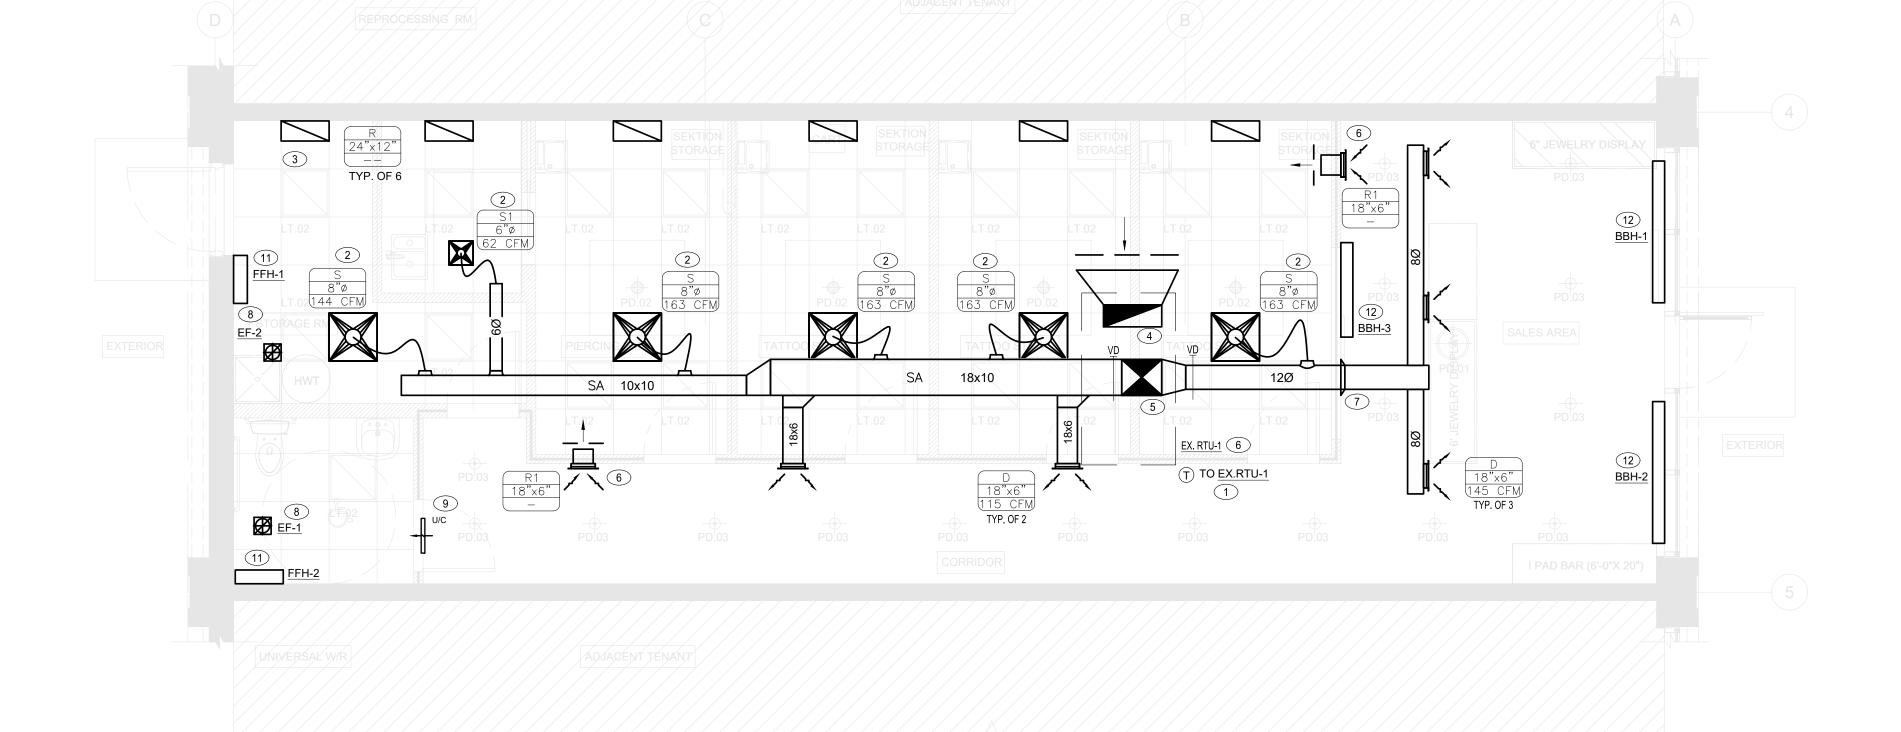

1 HVAC PLAN

M4.0 SCALE: 1/4"=1'-0"

	ELECTRIC WATER HEATER SCHEDULE							
No.	MANUFACTURER & MODEL	CAPACITY (GAL)	TYPE	GAS PRESSURE (in.W.C.)	ELECTRICAL	WATT	DIMENSIO NS IN	WEIGHT (LBS)
HWT-1	AO SMITH - DEL-15	15	ELECTRICAL		208V/1/60	3000		73
NOTES & R	REMARKS							

		PLUMB	ING FIXT	URE	SC	HED	JLE			
TYPE	SPECIFICATION	TRIM	TRAPS & SUPPLIES EQUAL TO	CW	FW	HW	110	WASTE	VENT	REMARKS
WC-1	AMERICAN STANDARD CADET 2467 016 ELONGATED	2 - PIECE WATER CLOSET ELONGATED C/W SEAT WITH COVER	INTEGRAL	1/2"	_	_	_	3"	1 1/2"	PROVIDE WHEELCHAIR SEAT CENTOCO #820STS" SEE SPEC. FOR AUTOMATIC CONTROL NOTES.
L-1	WALL HUNG BASIN (WHEELCHAIR USE) -AMERICAN STANDARD 'LUCERNE' #0355.012*  BRASS METERING FAUCET WITH LEVER HANDLE - SYMMONS SLC-6000	SLOAN #ETF-80-4-BDT; GRID STRAINER	MCGUIRE #155A DRAIN, #8872C-17T 'P' TRAP, SMITH SERIES #0700 CARRIER	1/2"	_	1/2"	_	1 1/4"	1 1/4"	MIXING VALVE - ZURN ZW3870XLT
S-1	IKEA PRODUCT: LILLANGEN FINISH: WHITE W/ S.S. LEGS C/W ENSEN FAUCET	IKEA PRODUCT: ENSEN FAUCET MODEL: 203.813.82 FINISH: STAINLESS STEEL	-	1/2"	_	1/2"	_	2"	1-1/2"	PROVIDE PROTECTIVE COVER FOR EXPOSED PIPEWORK P-TRAP, HW & CW ANGLE STOPS AND SUPPLIES. FOR NARROW WALL PROVIDE 'Z' TYPE SLEEVE FOR ARMS
S-2	IKEA PRODUCT: HILLESJON 1-1/2" BOWL DUAL MOUNT SINK MODEL: 10324886 INCLUDED: LILLVIKEN SINK STRAINER W/ STOPPER	IKEA PRODUCT: ALMAREN KITCHEN FAUCET MODEL: 503.416.43 FINISH: STAINLESS STEEL SEKTION BASE CABINET W/ 2 DOORS (36"X24"X30")	-	1/2"	_	1/2"	_	2"	1-1/2"	PROVIDE PROTECTIVE COVER FOR EXPOSED PIPEWORK P-TRAP, HW & CW ANGLE STOPS AND SUPPLIES. FOR NARROW WALL PROVIDE 'Z' TYPE SLEEVE FOR ARMS
MS-1	ZURN PRODUCT: Z1996-24 MOP SERVICE BASIN 24"XX24" MOLDED HIGH DENSITY COMPOSITE BASIN, PVC DRAIN BODY, STAINLESS STEEL AND 3 GASKETED OUTLET CONNECTION	ZURN PRODUCT: Z1996-SF SERVICE SINK FAUCET FINISH: CHROME PLATED SERVICE FAUCET, COMPLETED WITH VACUUM BREAKER, INTEGRAL STOPS, ADJUSTABLE WALL BRAVE, PAIL HOOK, FOUR-ARM HOT AND COLD HANDLE AND 3/4 HOSE THREAD ON SPOUT.	_	1/2"	_	1/2"	_	3"	2"	PROVIDE PROTECTIVE COVER FOR EXPOSED PIPEWORK P-TRAP, HW & CW ANGLE STOPS AND SUPPLIES. FOR NARROW WALL PROVIDE 'Z' TYPE SLEEVE FOR ARMS

EXHAUST FAN SCHEDULE											
TAG	SERVICE	TYPE	MANUFACTURER	MODEL	FLOW (CFM)	ESP ("W.G.)	RPM	MOTOR (HP)	VOLTAGE	WEIGHT (LBS)	REMARKS
EF-1 TO EF-2	WASHROOMS	CEILING EXHAUST FAN	GREENHECK	SP-A70-VG	70	0.375	838	10.8 WATTS	115/1/60	12	NEW
REMARKS			-		<u> </u>						

EXISTING TO REMAIN

							E	XISTII	NG R	OOF TO	OP U	NIT								
	SERVICE/					SUPPLY AIR		O/A		HEATING COIL			COOLING COI	L			PHYSICAL			
TAG	LOCATION	TON	MANUFACTURER	MODEL	FLOW (CFM)	ESP ("W.G.)	MOTOR (HP)	FLOW (CFM)	INPUT (MBH)	OUTPUT (MBH)	EFF.	EER.	TOTAL (MBH)	SENS. (MBH)	LENGTH (IN.)	WIDTH (IN.)	HEIGHT (IN.)	SOUND POWER (dBA)	WEIGHT (LBS)	REMARKS

					FLOW (CFM)	ESP ("W.G.)	MOTOR (HP)	(CFM)	(MBH)	(MBH)	E
EX. RTU	J-1 ROOF 1	OP 4	ALLIED	LGH048H4E	1600	0.7		221		350	
		A	IR TERM	INALS					E	ELEC1	۲R
TAG	SERVICE		DESCF	RIPTION		NOTES	TAG		TYPE		MF
	SQUARE		, 24"X24" ALUMINUM (				FFH-1	FAN FORCE	HEATER	S	STELF

- THIS CONTRACTOR SHALL VERIFY THE VOLTAGES OF ALL MECHANICAL EQUIPMENT WITH DIVISION 26 PRIOR TO ORDERING.

- ALL ROOF MOUNTED FANS TO BE SUPPLIED C/W ROOF CURB, BIRDSCREENS & WEATHERPROOF HOUSING.

ALL FIXTURES SHALL BE SUPPLIED & INSTALLED BY DIVISION 22 UNLESS OTHERWISE NOTED. MAKE ALL CONNECTIONS WITH BRAIDED FLEXIBLE HOSE.

		AIR I ERMINALS	
TAG	SERVICE	DESCRIPTION	NOTES
S/S1	SQUARE PLAQUE CEILING DIFFUSER	PRICE MODEL 'SPD', 24"X24" ALUMINUM CONSTRUCTION SQUARE PLAQUE CEILING DIFFUSERS, REFER TO DRAWING FOR NECK SIZES. CONTRACTOR TO REFER TO CEILING TYPE ON ARCHITECTURAL DRAWINGS AND PROVIDE CORRESPONDING MOUNTING REQUIREMENTS.  DIFFUSERS TAGGED "S1" SHALL BE 12"x12" FACE SIZE.	_
R	RETURN AIR GRILLE	PRICE MODEL '80D'. REFER TO DRAWING FOR GRILLE SIZES. CONTRACTOR TO REFER TO CEILING TYPE ON ARCHITECTURAL DRAWINGS AND PROVIDE CORRESPONDING MOUNTING FRAME REQUIREMENTS, T-BAR APPLICATION TO BE CORE ONLY LAY-IN TYPE.	1
D	SUPPLY AIR REGISTER	PRICE MODEL '520D'. DOUBLE DEFLECTION @ 45°, STEEL CONSTRUCTION, 3/4" SPACING C/W OPPOSED BLADE DAMPER. FRONT BLADE PARALLEL TO LONG DIMENSION. REFER TO DRAWING FOR GRILLE SIZES. REFER TO ARCHITECTURAL CEILING PLANS FOR MOUNTING REQUIREMENTS.	1,2
R1	RETURN AIR GRILLE	PRICE MODEL '530'. @ 45° BLADE DEFECTION, STEEL CONSTRUCTION, 3/4" SPACING C/W OPPOSED BLADE DAMPER. FRONT BLADE PARALLEL TO LONG DIMENSION. REFER TO DRAWING FOR GRILLE SIZES. REFER TO ARCHITECTURAL CEILING PLANS FOR MOUNTING REQUIREMENTS.	1
NOTES:		•	1

1. CONCEALED FASTENERS

C/W OPPOSED BLADE DAMPER

SUPPLIED AND INSTALLED MY MECHANICAL CONTRACTOR - ROUGH IN AND FINAL INSTALLATION.

TAG	TYPE	MFGR & MODEL	HEATING kW	VOLTAGE BLOWER MOTOR	REMARKS
FFH-1 & FFH-2	FAN FORCED HEATER	STELPRO MODEL: WF2008T	2 kW	208/1/60	INTERGRATED THERMOSTAT WALI MOUNTED RECESSED
BBH-1 & BBH-2	BASEBOARD HEATER	STELPRO MODEL: DBI18158	1.5 kW	208/1/60	
BBH-3	BASEBOARD HEATER	STELPRO MODEL: DBI12108	1 kW	208/1/60	

150

_				
-3	BASEBOARD HEATER	STELPRO MODEL: DBI12108	1 kW	208/1/60
S & R	EMARKS			
	UNIT TO BE SUPPLY AND INSTALL B	Y ELECTRICAL DIVISIO	N.	



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PROJECT TITLE:

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KILDONAN CROSSING 1616 REGENT AVE W WINNIPEG, MB R2C 5C6 CRU # 4

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SCHEDULES

PRINT DATE: 2023-05-18 AS NOTED DRAWING NO: DRAWN BY:

TW CHECKED BY:

23-1020

PROJECT NO:

### . GENERAL

#### 1.1. CONTRACTOR RESPONSIBILITIES

- 1.1.1. THE RESPONSIBILITY AND SCOPE OF EACH SUB-TRADE RESTS SOLELY WITH THE CONTRACTOR. EXTRAS WILL NOT BE CONSIDERED BASED ON THE GROUNDS OF DIFFERENCE IN INTERPRETATION OF SPECIFICATIONS AND DRAWINGS AS TO WHICH TRADE INVOLVED SHALL PROVIDE CERTAIN SPECIALTIES OR MATERIALS.
- .1.2. CONTRACTOR TO MAKE CERTAIN THAT ALL ADDENDA TO THE SPECIFICATIONS AND ALL REVISIONS TO THE DRAWINGS ARE INCLUDED IN THEIR QUOTATION.
- CONTRACTOR TO ENSURE THAT DELIVERY TIME OF ALL MECHANICAL EQUIPMENTS WILL NOT CAUSE A DELAY IN THE SCHEDULING OF THIS PROJECT.
- 1.4. ALL WORK AND MATERIALS SHALL COMPLY WITH THE CURRENT EDITION OF THE ALBERTA BUILDING CODE, LOCAL BUILDING REGULATIONS, AND ALL CODES AND AUTHORITIES HAVING JURISDICTION.
- 1.1.5. PRIOR TO SUBMITTING A TENDER THE CONTRACTOR SHALL NOTE ANY DISCREPANCIES AND BRING THEM TO THE ATTENTION OF THE ENGINEER. FURTHER, THE CONTRACTOR IS TO EXAMINE THE SITE, CONDITIONS AND ALL ASSOCIATED SCOPES OF WORK THAT FALL UNDER HIS CONTRACT AND DETERMINE THAT ALL COSTS FOR THE WORK ARE FULLY COVERED IN HIS TENDER SUBMISSION
- 1.1.6. DURING CONSTRUCTION THE CONTRACTOR SHALL ENSURE THAT ALL MATERIAL AND EQUIPMENT IS NEW AND MEETS OR EXCEEDS THE QUALITY AS SET OUT IN THE SPECIFIED EQUIPMENT AND APPLICABLE CODES. THE INSTALLATION OF ALL EQUIPMENT AND MATERIALS SHALL BE OF THE HIGHEST WORKMANSHIP AND QUALITY. ATTENTION TO DETAIL, SAFETY, NEATNESS, ACCESS FOR MAINTENANCE, DURABILITY, ETC. IS EXPECTED AND REQUIRED.
- 1.1.7. IF THE OWNER OR THEIR REPRESENTATIVE PRE-PURCHASES OR SUPPLIES EQUIPMENT OR MATERIALS, THE CONTRACTOR SHALL BE RESPONSIBLE FOR THE COMPLETE INSTALLATION OF THEM AS PER MANUFACTURERS RECOMMENDATIONS. OWNER FURNISHED ITEMS MUST MEET THE COMPLIANCE REQUIREMENTS OF THE CONTRACT DOCUMENTS.
- ALL EQUIPMENT IS TO BE SET STRAIGHT AND SQUARE WITH THE STRUCTURE. PIPING AND DUCTWORK IS TO BE INSTALLED PARALLEL OR AT RIGHT ANGLES TO ALL WALLS AND STRUCTURAL MEMBERS. HANGER RODS, EQUIPMENT BASES, SUPPORTS AND ISOLATION ARE TO BE SET PLUMB AND SQUARE AND IN VERTICAL ALIGNMENT WHERE APPLICABLE. ALL WORK IS TO BE NEAT AND CLEAN UPON COMPLETION.
- 1.1.9. THE CONTRACTOR SHALL MAKE NECESSARY REVISION, ALTERATIONS, CHANGES AND ADDITIONS TO ANY AND ALL WORK AS REQUIRED TO ACCOMMODATE OTHER TRADES SCOPE OF WORKS INCLUDING, ARCHITECTURAL, STRUCTURAL AND ELECTRICAL WITHOUT COST TO THE OWNER.
- 1.1.10. THE TERM "SUPPLY", "PROVIDE", "INSTALL" SHALL MEAN TO SUPPLY AND INSTALL ALL NECESSARY LABOUR, MATERIALS, TOOLS AND EQUIPMENT AS MAY BE NECESSARY TO INSTALL SAME FOR THE COMPLETE AND FUNCTIONAL OPERATION OF THE MECHANICAL SYSTEMS FOR THIS PROJECT.
- 1.1.11. THE CONTRACTOR SHALL BE RESPONSIBLE FOR THE TRANSPORTATION AND PROTECTION OF ALL EQUIPMENT AND MATERIAL PROVIDED FOR THIS PROJECT UNTIL THE OWNER HAS ACCEPTED THE BUILDING. THIS SHALL INCLUDE STORAGE OF SAME ON SITE AND REMOVAL OF ALL MATERIALS AND REFUSE AS A RESULT.
- 1.1.12. PROVIDE ALL NECESSARY SCAFFOLDING, LADDERS, HOISTS, RIGGING, ETC. AS REQUIRED FOR THE INSTALLATION OF THE WORK WITHIN THIS SCOPE. ALL HOISTING, SUPPORTS, DELIVERY, ETC OF EQUIPMENT AND MATERIAL FOR THIS PROJECT SHALL BE THE RESPONSIBILITY OF THIS CONTRACTOR.
- 1.1.13. THE CONTRACTOR IS RESPONSIBLE FOR THE PROTECTION OF THE BUILDING, WORK OF OTHERS, ETC. DURING THE COURSE OF CARRYING OUT THE WORK AS INVOLVED IN THIS CONTRACT. THE CONTRACTOR SHALL MAKE GOOD AND/OR PAY FOR ANY DAMAGES SUSTAINED. THE OWNER RESERVES THE RIGHT TO BACKCHARGE THE CONTRACTOR FOR THE REPAIR AND/OR REPLACEMENT OF ANY DAMAGES.
- 1.1.14. THE CONTRACTOR SHALL OBTAIN ALL NECESSARY PERMITS AND APPROVALS AND PAY FOR ALL NECESSARY FEES OR OTHER COSTS ASSOCIATED WITH CARRYING OUT THE WORK HEREIN. THE CONTRACTOR IS RESPONSIBLE FOR PROVIDING ANY AND ALL CERTIFICATES AS REQUIRED TO ENSURE THAT THE INSTALLATION IS IN CONFORMANCE WITH, AND HAS BEEN APPROVED BY ALL AUTHORITIES HAVING JURISDICTION. ANY REVISIONS AND/OR CHANGES REQUIRED BY THE AUTHORIZED INSPECTOR SHALL BE DONE WITHOUT CHARGE TO THE OWNER AND SHALL BE DONE SO AS NOT TO AFFECT SCHEDULE OR THE WORK OF OTHERS. ALL PERMITS SHALL BE POSTED IN A CONSPICUOUS PLACE ON SITE. UPON COMPLETION THIS CONTRACTOR IS TO PROVIDE THE OWNER WITH A CERTIFICATE OF FINAL APPROVAL FROM ALL AUTHORITIES INVOLVED IN THE SCOPE OF THIS WORK.
- 1.1.15. IN CARRYING OUT THE WORK THE CONTRACTOR SHALL USE ONLY FULLY QUALIFIED TRADESPEOPLE RECOGNIZED UNDER MUNICIPAL, PROVINCIAL AND FEDERAL REGULATIONS AND LICENSING.
- 1.1.16. THE CONTRACTOR IS TO PROVIDE ALL NECESSARY INFORMATION ON REQUIRED OPENINGS, SLEEVES, AND CHASES AS MAY BE REQUIRED FOR HIS WORK TO ALL OTHER TRADES INVOLVED SO THAT THE WORK MAY BE DONE IN A TIMELY AND COST EFFECTIVE MANNER. FAILURE TO DO SO WILL RESULT IN ANY COSTS BEING CHARGED BACK TO THE CONTRACTOR. ALL DRILLING FOR HANGER RODS, BRACKETS, SUPPORTS, SLEEVES, ETC. SHALL BE BY THIS CONTRACTOR.
- 1.1.17. INSTALL ALL PIPING, DUCTWORK, EQUIPMENT, ETC. GENERALLY IN THE ROUTES AND LOCATIONS AS SHOWN ON THE DRAWINGS. INSTALL ALL MATERIAL AND EQUIPMENT CLOSE TO STRUCTURE TO MINIMIZE, SHAFTS, FURRINGS, ETC. PIPING AND DUCTWORK THAT IS NOT INSTALLED PROPERLY SHALL BE REMOVED AND RE-INSTALLED AT NO EXTRA COST
- 1.1.18. THIS CONTRACTOR IS TO CO-ORDINATE THE DETAILED INSTALLATION OF THE DUCTWORK, PIPING AND EQUIPMENT WITH ALL CONDUIT, CABLE TRAYS, STRUCTURAL ELEMENTS, AND OTHER WORK OF THE OTHER TRADES. NO ADDITIONAL COSTS WILL BE CONSIDERED FOR CHANGES AS THE RESULT OF INTERFERENCE WITH THE WORK OF OTHERS. THIS INCLUDES ANY ADDITIONAL MATERIAL REQUIRED TO CORRECT MINOR JOB CONFLICTS FOR NORMALLY ACCEPTED PROCEDURES OF ANY AND ALL TRADES.
- 1.1.19. THIS CONTRACTOR IS RESPONSIBLE FOR THE INSTALLATION OF ALL NECESSARY ISOLATION VALVES, SPRING ISOLATORS, SHUT-OFFS, UNIONS, COUPLINGS, ETC. AS MAY BE REQUIRED FOR THE SAFE OPERATION AND CONTINUED MAINTENANCE OF ALL SYSTEMS AND EQUIPMENT. THIS SHALL INCLUDE ALL NECESSARY COMPONENTS AS MAY BE REQUIRED BY THE MANUFACTURER AS NOTED IN THEIR RESPECTIVE LITERATURE AND INSTALLATION DETAILS.
- 1.1.20. THE CONTRACTOR MAY USE EQUIVALENT EQUIPMENT AND MATERIALS FROM AN APPROVED MANUFACTURER OTHER THAN THAT SPECIFICALLY SPECIFIED. THE USE OF SAME DOES NOT RELIEVE THE CONTRACTOR FROM CONFIRMING TO OTHER TRADES AFFECTED ALL RELEVANT INFORMATION SUCH AS DIMENSIONS, ELECTRICAL, WEIGHT, ETC. ANY NECESSARY REVISIONS AS A RESULT SHALL BE PAID FOR BY THIS CONTRACTOR. IF THE PROPOSED EQUIPMENT OR NECESSARY MODIFICATIONS ARE NOT TO THE SATISFACTION OF THE ENGINEER THAT THE END RESULT WILL BE THE SAME THE CONTRACTOR SHALL PROVIDE THE SPECIFIED EQUIPMENT AT NO ADDITIONAL COST TO THE OWNER.
- 1.1.21. ALL EQUIPMENT AND MATERIAL SPECIFIED AND NOTED ON THE DRAWINGS IS SET AS A MINIMUM STANDARD FOR THE CONTRACTOR TO WORK TO. ALL SUBMITTED TENDERS SHALL BE BASED ON MATERIAL AND EQUIPMENT AS SPECIFIED. EQUIPMENT AND MATERIAL SUPPLIERS OTHER THAN THOSE SPECIFIED ARE TO MAKE A WRITTEN SUBMISSION FOR CONSIDERATION AS AN EQUAL OR ALTERNATE ALONG WITH ANY COST SAVINGS THAT MAY BE REALIZED AS A RESULT OF USING THIS EQUIPMENT. SUBMISSION FOR CONSIDERATION AS AN EQUAL SHALL BE MADE, ALONG WITH TECHNICAL INFORMATION, A MINIMUM OF 2 DAYS BEFORE TENDERS CLOSE.
- 1.1.22. THE CONTRACTOR SHALL NOT USE THE PERMANENT HEATING SYSTEM FOR TEMPORARY HEATING WITHOUT WRITTEN PERMISSION FROM THE OWNER/ENGINEER. ANY EQUIPMENT THAT IS USED SHALL BE CLEANED, LUBRICATED AND NEW FILTERS INSTALLED PRIOR TO TURNING OVER TO OWNER FOR COMPLETION.
- 1.1.23. BEFORE FABRICATION AND INSTALLATION OF DUCTWORK AND PIPING, MAKE CERTAIN THAT ALL ITEMS CAN BE INSTALLED AS SHOWN ON THE DRAWINGS WITHOUT INTERFERENCE WITH THE STRUCTURE OR THE WORK OF OTHER TRADES. IF ANY MATERIALS ARE FABRICATED OR INSTALLED PRIOR TO THE INVESTIGATION AND REACHING OF A SOLUTION TO POSSIBLE INTERFERENCE PROBLEMS, NECESSARY CHANGES SHALL BE MADE AT THE CONTRACTOR'S EXPENSE.

### 1.2. EXAMINATION OF WORK

- 1.2.1. DRAWINGS ARE DIAGRAMMATIC AND APPROXIMATELY TO SCALE. THE CONTRACT DOCUMENTS ESTABLISH SCOPE, MATERIAL AND QUALITY AND ARE NOT DETAILED INSTALLATION INSTRUCTIONS.
- 2.2. THE CONTRACTOR SHALL BECOME FAMILIAR WITH THE BUILDING, STRUCTURE AND THE WORKS OF THE OTHER TRADES INVOLVED. THIS CONTRACTOR SHALL WORK AND CO-OPERATE WITH THE OTHER TRADES TO ENSURE A QUALITY INSTALLATION, AND MINIMIZE CONFLICTS.

#### 1.3. <u>INTENT</u>

- 1.3.1. IT IS THE INTENT OF THIS SPECIFICATION AND DRAWINGS TO PROVIDE FOR A COMPLETE AND FULLY OPERATING SYSTEM IN COMPLETE ACCORD WITH ALL APPLICABLE CODES. THESE SPECIFICATIONS MAY NOT COVER EACH AND EVERY ITEM REQUIRED FOR THE COMPLETE MECHANICAL INSTALLATION. THEREFORE, THE CONTRACTOR SHALL MAKE HIS OWN PROVISIONS FOR ALL LABOUR, MATERIALS AND EQUIPMENTS DEEMED NECESSARY TO COMPLETE THE MECHANICAL SYSTEM.
- 1.3.2. THE SPECIFICATIONS ARE INTEGRAL WITH THE DRAWINGS WHICH ACCOMPANY THEM. NEITHER IS TO BE USED ALONE. ANY ITEM OR SUBJECT OMITTED FROM ONE, BUT IMPLIED ON THE OTHER IS PROPERLY SPECIFIED.
- 3.3. WHENEVER DIFFERENCES OCCUR IN THE CONTRACT DOCUMENTS, THE MAXIMUM CONDITION WILL GOVERN AND BE INCLUDED IN THE CONTRACT PRICE.
- 1.3.4. CONFORM TO MANUFACTURER'S INSTRUCTIONS, DETAILS AND PROCEDURES FOR EQUIPMENT INSTALLATIONS.
  - CONFIRM ALL NEW EQUIPMENT LOADING AND SUPPORT WITH STRUCTURAL ENGINEER PRIOR TO INSTALLATION.

#### .4. QUALITY ASSURANCE

- 1.4.1. COMPLY WITH ALL PROVINCIAL AND LOCAL CODES FOR PROVISION OF MATERIALS, LABOUR AND INSTALLATION.
- 1.4.2. USE TRADESMAN LICENSED BY PROVINCIAL AUTHORITIES FOR THE WORK SPECIFIED IN THIS SECTION.
- 1.4.3. USE HIGHEST QUALITY PIPING CONFORMING TO THE APPROPRIATE ASTM AND CSA
- 1.4.4. ALL MUNICIPAL BYLAWS AND NFPA STANDARDS GOVERNING THE INSTALLATION SHALL BE STRICTLY ADHERED TO.
- 1.4.5. CONCEALED OR INSULATED WORK SHALL REMAIN UNCOVERED UNTIL REQUIRED TESTS HAVE BEEN COMPLETED, BUT IF CONSTRUCTION SCHEDULE REQUIRES, ARRANGE FOR PRIOR TESTS ON PARTS OF SYSTEM AS APPROVED.

#### 1.5. INSURANCE

- 1.5.1. THE CONTRACTOR MUST HAVE COMPREHENSIVE GENERAL LIABILITY INSURANCE COVERAGE OF NOT LESS THAN \$2,000,000.00 INCLUDING NON OWNED CAR COVERAGE, CONTRACTUAL LIABILITY AND CONTAINING A CROSS LIABILITY CLAUSE. COVERAGE SHALL INCLUDE LOSS OR DAMAGE CAUSED BY THE CONTRACTOR.
- 1.5.2. THE CONTRACTOR SHALL CARRY FULL EMPLOYEE'S LIABILITY INSURANCE IN ACCORDANCE WITH THE WORKER'S COMPENSATION ACT.

#### I IARII ITY

- 1.6.1. THIS CONTRACTOR SHALL ASSUME FULL RESPONSIBILITY FOR LAYING OUT HIS WORK AND FOR ANY DAMAGE CAUSED TO OWNER OR OTHER CONTRACTOR BY IMPROPER LOCATION OR CARRYING OUT HIS WORK.
- 1.6.2. THIS CONTRACTOR SHALL PROTECT ALL FINISHED AND UNFINISHED WORK OF HIS OWN AND OTHER CONTRACTORS, INCLUDING EXISTING FROM DAMAGE DUE TO CARRYING OUT HIS WORK.

#### .7. COORDINATION AND CO-OPERATION

- 1.7.1. COORDINATE WORK WITH ALL OTHER SUBCONTRACTORS AND TRADES INVOLVED.
- 7.2. CONFIRM IN WRITING TO GENERAL CONTRACTOR/ENGINEER ANY EXISTING SERVICES OR WORKS DEEMED TO BE UNACCEPTABLE/DEFECTIVE PRIOR TO COMMENCING WORK.
- 1.7.3. THESE DRAWINGS SHALL BE READ IN CONJUNCTION WITH ARCHITECTURAL, STRUCTURAL, LANDSCAPE, IRRIGATION CIVIL, FIRE PROTECTION, GEOTECHNICAL AND ELECTRICAL DRAWINGS. REPORT ANY DISCREPANCIES TO ENGINEER PRIOR TO TENDER CLOSE

### 1.8. CERTIFICATES, FEES, ETC.

- 1.8.1. GIVE ALL NOTICES, OBTAIN ALL PERMITS AND PAY ALL FEES SO THAT THE WORK SPECIFIED MAY BE CARRIED OUT. FURNISH ANY CERTIFICATES AT THE OWNER'S REQUEST AS EVIDENCE THAT WORK INSTALLED CONFORMS WITH THE LAWS AND REGULATIONS OF ALL AUTHORITIES HAVING JURISDICTIONS CERTIFICATES/PERMITS
- 1.8.2. INSPECTIONS SHALL BE MADE PROMPTLY. IF ANY WORK IS COVERED UP WITHOUT CONSENT, IT SHALL, IF REQUIRED, BE UNCOVERED FOR EXAMINATION AND MADE GOOD AT NO EXTRA COST TO OWNER

ARE TO BE PROVIDED FOR QUALITY OF WORKMANSHIP AND WORKMAN QUALIFICATIONS.

- 1.8.3. GIVE NECESSARY NOTICES, OBTAIN NECESSARY PERMITS AND PAY REQUIRED FEES AND TAXES IN ORDER THAT THE WORK UNDER THIS CONTRACT MAY BE CARRIED OUT.
- 1.8.4. BE RESPONSIBLE TO FILE THE NECESSARY PLANS, TO PREPARE FOR AND OBTAIN APPROVAL OF DOCUMENTS AS REQUIRED BY GOVERNMENT DEPARTMENTS HAVING JURISDICTION AND TO OBTAIN CERTIFICATES OF INSPECTION REQUIRED. DELIVER THESE TO THE CONSULTANT PRIOR TO REQUEST FOR ACCEPTANCE AND FINAL PAYMENT OF THE WORK.
- 1.8.5. WORK AND MATERIALS SHALL BE IN COMPLETE ACCORDANCE WITH THE APPROVAL OF LOCAL CODES AND AUTHORITIES HAVING JURISDICTION.
- 1.8.6. PROVIDE CHANGES THAT ARE REQUIRED BY THE AUTHORITIES HAVING JURISDICTION, AS PART OF THE CONTRACT AND GIVE IMMEDIATE NOTIFICATION OF SUCH CHANGES TO THE CONSULTANT.
- .8.7. COMPLY WITH ALL CURRENT EDITIONS OF RELEVANT CODES AND REGULATIONS INCLUDING THE FOLLOWING:
  - 1.8.7.A THE 2014 ALBERTA BUILDING CODE.1.8.7.B THE 2015 NATIONAL PLUMBING CODE.

### 1.9. STANDARD OF WORKMANSHIP AND MATERIALS

- 1.9.1. MAKE AND QUALITY OF MATERIALS USED ARE SUBJECT TO APPROVAL BY THE ENGINEER. REMOVE CONDEMNED MATERIALS AND INSTALL SUITABLE MATERIALS IN THEIR PLACE.
- 1.9.2. MATERIAL SHALL BE NEW AND UNIFORM PATTERN THROUGHOUT.
- 1.9.3. EMPLOY ONLY TRADESMAN WITH PROPER LICENSE FOR WORK.

### .10. INSPECTIONS (SUBSTANTIAL COMPLETION)

- 10.1. GENERAL CONTRACTOR AND/OR MECHANICAL CONTRACTOR TO PROVIDE PRELIMINARY SCHEDULE FOR THE SITE REVIEW LISTED BELOW TO ENGINEER PRIOR TO COMMENCING CONSTRUCTION
- 1.10.2. SITE REVIEW REQUIRED;
- 1.10.2.A. FINAL REVIEW.
- 1.10.3. GENERAL CONTRACTOR AND/OR MECHANICAL CONTRACTOR TO NOTIFY CONSULTANT 2 WEEKS PRIOR TO ESTIMATED REVIEW DATES. RECONFIRM EXACT REVIEW DATES MINIMUM 3 BUSINESS DAYS PRIOR TO REQUIRED INSPECTION.
- 1.10.4. NOTIFY CONSULTANT 5 DAYS PRIOR TO FINAL INSPECTION. ALL SYSTEMS SHALL BE FULLY OPERATIONAL AND ANY DEFICIENCIES SHALL BE IDENTIFIED TO ENGINEER.
- 1.10.5. ALL DEFICIENCIES SHALL BE COMPLETED WITHIN 2 WEEKS AFTER SUBSTANTIAL COMPLETION. FAILURE TO COMPLETE WORK WITHIN THE TIME FRAME WILL RESULT IN WORK BEING DONE BY THE OWNER AND THE COST BEAR BY THE CONTRACTOR.

### 1.11. APPROVALS

- 11.1. THE PRICE SUBMITTED FOR THIS CONTRACT SHALL BE BASED ON THE USE OF MATERIALS AND EQUIPMENTS SPECIFIED. IF THIS CONTRACTOR WISHES TO QUOTE ON EQUIVALENT MATERIALS AND EQUIPMENTS, HE MUST QUOTE ON PRODUCTS APPROVED BY THE ENGINEER IN WRITING, AS AN EQUIVALENT TO THE PRODUCT SPECIFIED.
- 1.11.2. THIS CONTRACTOR SHALL BE FULLY RESPONSIBLE FOR ANY ADDITIONAL WORK OR

- MATERIALS REQUIRED BY THE MECHANICAL TRADE OR OTHER CONTRACTORS TO ACCOMMODATE APPROVED EQUIVALENT MATERIALS OR EQUIPMENTS. EXTRAS SHALL NOT BE APPROVED TO COVER SUCH WORK.
- 1.11.3. ALL MATERIALS AND EQUIPMENTS SHALL BE NEW. RECYCLED/OLD/REFURBISHED SHALL NOT BE ACCEPTED UNLESS PROVIDED BY THE OWNER OR THE OWNERS REPRESENTATIVE AS OWNER SUPPLIED EQUIPMENT.

### .12. VALUATION OF CHANGES

- 2.1. FOR EACH CHANGE, SUBMIT A COMPLETE, ITEMIZED BREAKDOWN OF LABOUR AND MATERIAL AT NET COST, SHOWING QUANTITIES, UNIT COST, HOURS PER EACH ITEM INSTALLED PROFIT OVERHEAD FTC
- ONLY THE NET DIFFERENCE BETWEEN AN EXTRA AND A CREDIT WILL BE SUBJECT TO OVERHEAD AND PROFIT MARK UP.

#### 13. GUARANTEE

- 1.13.1. THE MECHANICAL SUBCONTRACTOR, AS A CONDITION PRECEDENT TO FINAL PAYMENT AFTER COMPLETION OF HIS WORK, SHALL GIVE OWNER A WRITTEN GUARANTEE WARRANTING ALL APPARATUS FURNISHED UNDER THE CONTRACT FOR A PERIOD OF TWO YEARS OR NO LESS THAN THE MINIMUM REQUIRED BY THE NEW HOME WARRANTY FROM THE DATE OF FINAL ACCEPTANCE OF HIS WORK BY THE ARCHITECT AND ENGINEER.
- 1.13.2. BIND ALL GUARANTEE AND WARRANTY CERTIFICATES IN MAINTENANCE MANUALS.
- 13.3. ATTEND IMMEDIATELY AT NO COST TO OWNER, TO ANY AND ALL DEFECTS OCCURRING DURING THE WARRANTEE PERIOD.

#### 1.14. SHOP DRAWINGS

- 1.14.1. BEFORE FABRICATION OF ANY MATERIALS OR EQUIPMENT, SUBMIT A COMPLETE SET OF SHOP DRAWINGS, DATA SHEETS AND ONE (1) ELECTRONIC COPY COVERING ALL ITEMS OF EQUIPMENT FURNISHED AND INTENDED FOR INSTALLATION.
- 1.14.2. THE ENGINEER'S REVIEW SHALL NOT RELIEVE THIS CONTRACTOR FROM RESPONSIBILITY TO PROVIDE MATERIALS AND EQUIPMENTS IN ACCORDANCE WITH THE DESIGN INTENT AND CONTRACT DOCUMENTS. ALL DIMENSIONS AND SUITABILITY FOR SITE CONDITIONS ARE THE RESPONSIBILITY OF THE CONTRACTOR, ALL ELECTRICAL CHARACTERISTICS MUST BE COORDINATED WITH THE ELECTRICAL SUB-CONTRACTOR.`
- 1.14.3. DO NOT PURCHASE ANY EQUIPMENTS PRIOR TO APPROVAL OF SHOP DRAWINGS.
- 1.14.4. BE RESPONSIBLE FOR PRESENTING AND EXPEDITING THE PROCESSING OF SHOP DRAWINGS TO SUIT MANUFACTURING SCHEDULE OF EQUIPMENT AND CONSTRUCTION SCHEDULE OF BUILDING
- 1.14.5. EACH SHOP DRAWING SHALL INDICATE CLEARLY THE CORRECT NAME AND ADDRESS OF THE PROJECT, THE INTENDED USE AND LOCATION OF THE EQUIPMENT, AND THE SPECIFIED DESIGNATION NUMBER.
- 1.14.6. DRAWING PACKAGES TO BE SUBMITTED IN CONGRUENT GROUPS THAT MATCH EQUIPMENT SCHEDULE. IE. ALL PUMPS IN ONE PACKAGE.
- 1.14.7. CONTRACTOR TO SUBMIT SHOP DRAWINGS FOR ALL EQUIPMENT LISTED IN SCHEDULES AS WELL AS ALL PRE-MANUFACTURED SYSTEMS AND ASSOCIATED PRODUCTS. IE. PLASTIC PIPING SYSTEMS. VALVES. TRIM. AIR SEPARATOR ETC.

### 1.15. RECORD "AS-BUILT" DRAWINGS

- 1.15.1. KEEP IN THE JOB OFFICE AN EXTRA SET OF WHITE PRINTS AND SPECIFICATIONS ON WHICH ALL CHANGES AND DEVIATIONS SHALL BE RECORDED DAILY. AT COMPLETION OF THE PROJECT, TURN OVER TO THE ENGINEER THREE SETS OF NEAT AS-BUILT DRAWINGS AND SPECIFICATIONS.
- 1.15.2. UPON COMPLETION, THE CONTRACTOR SHALL SUPPLY TO THE OWNER ONE SET OF MARKED-UP RECORD DRAWINGS INDICATING ALL DIMENSIONS, INVERTS, DISTANCES FROM STRUCTURE, ETC. AS DONE ON SITE. PROVIDE 3 SETS OF OPERATION AND MAINTENANCE MANUALS THAT WILL INCLUDE APPROVED SHOP DRAWINGS, ETC. IN 3 RING BINDERS NEATLY BOUND AND LABELED.

#### 16. OPERATION AND MAINTENANCE DATA

- 1.16.1. FURNISH THREE SETS OF OPERATING AND MAINTENANCE DATA FOR ALL EQUIPMENTS AND SYSTEMS. DATA SHALL BE ASSEMBLED IN BOOK FORM WITH HARD COVER AND INDEX, IDENTIFY FRONT COVER WITH NAME AND LOCATION OF THE PROJECT, CONSULTING ENGINEER AND CONTRACTOR. PRIOR TO SUBSTANTIAL COMPLETION SUBMIT ONE COPY TO ENGINEER. REVIEW WITH CONSULTANT/OWNER IF DIGITAL O&M MANUAL IS ACCEPTABLE PRIOR TO TENDER CLOSE.
- 1.16.2. THE OPERATION AND MAINTENANCE MANUALS SHALL CONTAIN THE FOLLOWING AS A

M	IINIMUM:	
	TABLE OF CONTENTS	EQUIPMENT SUPPLIERS
	TABBED DIVIDERS	PARTS LIST
	INDEX	TROUBLESHOOTING
	SYSTEMS DESCRIPTION	TESTING/INSPECTION CERTIFICATES
		SHOP DRAWINGS
	MAINTENANCE TASKS	BALANCING REPORTS
	LUBRICATION INFORMATION	IDENTIFICATION DIRECTORY
	LIST OF CONTRACTORS	

### 17. <u>TURNOVER SEMINAR</u>

LOCAL INSPECTION AGENCIES.

AUTHORITIES HAVING JURISDICTION.

MANUFACTURER'S INSTALLATION

AND MAINTENANCE DATA SHEETS

1.17.1. AT COMPLETION OF PROJECT, MECHANICAL CONTRACTOR SHALL ORGANIZE AND CONDUCT A 1 HOUR SEMINAR TO INSTRUCT OWNER'S REPRESENTATIVES IN OPERATION AND PREVENTATIVE MAINTENANCE OF EQUIPMENT AND SYSTEMS.

### 1.18. <u>TESTIN</u>

- 1.18.1. TEST ALL EQUIPMENTS AND MATERIALS WHERE REQUIRED BY SPECIFICATIONS OR AUTHORITIES HAVING JURISDICTION, TO DEMONSTRATE ITS PROPER OPERATION TO THE OWNER'S REPRESENTATIVE. TEST PROCEDURES SHALL BE IN ACCORDANCE WITH APPLICABLE PORTIONS OF THE ASME, ASHRAE, SMACNA, NFPA, CSA AND OTHER RECOGNIZED TEST CODES AS FAR AS FIELD CONDITIONS PERMIT.
- 1.18.2. NOTIFY THE OWNER/ENGINEER PRIOR TO STARTING ANY TESTING. THE CONTRACTOR SHALL BE RESPONSIBLE FOR ALL DAMAGES THAT OCCUR AS A RESULT OF TESTING. HE SHALL BE RESPONSIBLE FOR ALL COSTS ASSOCIATED WITH LIABILITY AND REPAIRS AS
- ALL DEFECTS, LEAKS, ETC. SHALL BE REPAIRED OR REPLACED IMMEDIATELY UPON DISCOVERY. LEAKING JOINTS SHALL BE RE-DONE AND COMPLETED IN A TIMELY
- 1.18.4. PERFORMANCE TESTS SHALL BE CARRIED OUT UPON COMPLETION OF PRESSURE TESTS AND INSTALLATION. THE CONTRACTOR SHALL MAKE ALL NECESSARY CHANGES AND MODIFICATIONS AS REQUIRED TO DELIVER AN OPERATIONAL SYSTEM.
- 1.18.5. ALL TESTS SHALL BE A MINIMUM OF THE FOLLOWING: CONFIRM REQUIREMENTS OF
- 1.18.6. DOMESTIC WATER PIPING: TEST TO 1.5 TIMES MAXIMUM WORKING PRESSURE OR 1035 kPa (150 PSI) WATER PRESSURE MEASURED AT SYSTEM LOW POINT. FOR A MINIMUM OF
- 1.18.7. DRAINAGE SYSTEM: TEST BY FILLING WITH WATER TO PRODUCE WATER PRESSURE OF 3m (10ft) OF WATER COLUMN MINIMUM AND 10m (33ft) WATER COLUMN MAXIMUM FOR A DURATION OF 8 HOURS. CHECK FOR PROPER GRADE AND OBSTRUCTION BY BALL TEST.
- LEAKS DO OCCUR IMMEDIATELY REPAIR AND REPLACE.

  1.18.9. MECHANICAL CONTRACTOR IS TO TEST AND VERIFY IN WRITING ALL CONTROL SYSTEMS ARE OPERATING AS PER SPECIFICATION..

1.18.8. ALL TESTS SHALL BE MAINTAINED WITH NO APPRECIABLE LOSS OF PRESSURE. WHERE

- 1.18.10. ALL HYDRONIC PIPING SHALL BE TESTED AS REQUIRED BY PIPE MANUFACTURER AND
- 1.18.11. HYDRONIC HEATING PIPING: TEST TO 1.5 TIMES MAX. WORKING PRESSURE OR 1035 KPA (150PSI) WATER PRESSURE MEASURED AT SYSTEM LOW POINT FOR A MINIMUM OF 8 HOURS.

1.18.12. WATER BALANCING SHALL BE CARRIED OUT BY AN INDEPENDENT AGENCY SPECIALIZING IN THIS FORM OF WORK AND IN ACCORDANCE WITH GUIDELINES ESTABLISHED BY THE CURRENT ADDITION OF THE ALBERTA BUILDING CODE.

### 19. EQUIPMENT CLEANUP

- 1.19.1. DUCTS AND EQUIPMENTS SHALL BE THOROUGHLY CLEANED OF DIRT, CUTTINGS AND OTHER FOREIGN SUBSTANCES. DISCONNECT, CLEAN AND RECONNECT WHENEVER NECESSARY FOR THE PURPOSE OF LOCATING AND REMOVING OBSTRUCTIONS. REPAIR WORK DAMAGED IN THE CAUSE OF REMOVING OBSTRUCTIONS. DUCTS SHALL BE PROFESSIONALLY VACUUM CLEANED PRIOR TO TURNING OVER TO OWNER.
- 1.19.2. REPAIR ANY TEMPORARY EQUIPMENT USED FOR TEMPORARY HEAT, TO THE FULL SATISFACTION OF THE OWNER.
- 1.19.3. REMOVE ALL TOOLS, WASTE MATERIAL, GARBAGE, PACKAGING MATERIALS GENERATED FROM THIS SCOPE OF WORK FROM SITE. UPON COMPLETION ENSURE ALL SURFACES ARE CLEANED OF GREASE, DIRT, ETC. ONCE COMPLETED THE FACILITY SHALL BE AVAILABLE FOR IMMEDIATE USE.

#### 0. IDENTIFICATION

- I.20.1. PROVIDE FOR IDENTIFICATION OF PIPING AND DUCTWORK WITH MARKERS SHOWING SERVICE AND DIRECTION OF FLOW. APPLY LABELS AT MAXIMUM 15m (50ft) INTERVALS, BEFORE AND AFTER PASSING THROUGH WALLS, AT ACCESS DOOR OPENINGS, AT EACH SHUT OFF VALVE AND ADJACENT TO EACH PIECE OF EQUIPMENT. LABELS SHALL BE WATERPROOF AND HEAT RESISTANT WITH YELLOW BACKGROUND, MINIMUM 25mm (1") LETTERING AND DRY ADHESIVE BACKING. PROVIDE 3M #76 ADHESIVE IN ADDITION TO DRY ADHESIVE BACKING.
- 1.20.2. PROVIDE 50mm (2") WIDE COLOUR BAND OF PLASTIC PRESSURE SENSITIVE TAPE FOR PIPING SYSTEMS. SPACING SHALL BE SAME AS LABELS.
- 1.20.3. TAG AUTOMATIC CONTROLS, ELECTRIC SWITCHES, INSTRUMENTS AND RELAYS WITH LAMICOID LABELS WITH 15mm (1/2") LETTERS AND KEY WITH CONTROL SCHEMATICS.
- 1.20.4. PROVIDE LAMICOID LABELS WITH 15mm (1/2") LETTERS ON EQUIPMENT AND MOTOR

#### . CUTTING AND PATCHING

- 1.21.1. THE MECHANICAL CONTRACTOR SHALL INCLUDE AND BE RESPONSIBLE FOR CUTTING, PATCHING AND MAKE GOOD ALL OPENINGS REQUIRED FOR THE MECHANICAL SERVICES.
- 1.21.2. LOCATE HOLES AND PROVIDE SLEEVES, CUTTING AND FITTING REQUIRED FOR MECHANICAL WORK. RELOCATE IMPROPERLY LOCATED HOLES AND REPAIR WORK
- 1.21.3. PROVIDE EXPANSION BOLTS, HANGER RODS, BRACKETS AND SUPPORTS.
- 1.21.4. DO NOT ALTER STRUCTURAL MEMBERS OF BUILDING WITHOUT OBTAINING APPROVAL FROM ARCHITECT AND STRUCTURAL ENGINEER.
- 1.21.5. PERFORM PATCHING OF FINISHED WORK IN ACCORDANCE WITH THE APPLICABLE SECTIONS OF SPECIFICATIONS.

### 1.22. <u>FLASHING</u>

1.22.1. DO ALL FLASHING AND COUNTER FLASHING WHERE DUCTS AND OTHER MECHANICAL PARTS ARE PASSING THROUGH WEATHER AND/OR WATER PROOF WALLS, FLOORS AND ROOFS, ALL TO THE SATISFACTION OF THE OWNER.

### .23. PIPE HANGARS, SUPPORTS AND SLEEVES

- 1.23.1. ALL HANGERS AND HANGER RODS SHALL BE SUPPLIED AND INSTALLED BY THIS CONTRACTOR FOR THE INSTALLATION OF HIS WORK IN THIS DIVISION.
- 1.23.2. HANGERS AND SUPPORTS SHALL SECURE PIPES IN PLACE, PREVENT VIBRATION, MAINTAIN GRADE BY ADJUSTMENT, PROVIDE FOR EXPANSION AND CONTRACTION. ALL SUPPORTS SHALL BE DIRECTLY FROM THE STRUCTURE, AND NOT FROM OTHER
- 1.23.3. PROVIDE SUPPORTS AND CLEVIS TYPE HANGERS ON OUTSIDE OF INSULATION.
- INSTALLATION SHALL MEET THE REQUIREMENTS OF APPLICABLE CODES.1.23.4. USE OF PERFORATED STRAP, WIRE OR CHAIN HANGERS IS NOT PERMITTED.
- LOOP TYPE HANGERS.

1.23.5. STEEL PIPES UP TO AND INCLUDING 100mm (4") DIAMETER, USE HEAVY DUTY CLEVIS OR

- 1.23.6. COPPER PIPES, USE HANGERS IN COPPER PLATE FINISH OR STEEL LOOP HANGER W/ APPROVED ELECTROLYSIS BARRIER (POLY TAPE).
- 1.23.7. CAST IRON PIPES USE HEAVY-DUTY CLEVIS OR LOOP TYPE HANGERS.1.23.8. SUPPORT PIPES IN ACCORDANCE WITH THE CURRENT EDITION OF THE NATIONAL

PLUMBING CODE, MANUFACTURER'S RECOMMENDATIONS, ASHRAE STANDARDS AND/OR

1.23.9. PROVIDE HANGERS AND SUPPORTS FOR ALL DUCTWORK, IN ACCORDANCE WITH SMACNA - "H.V.A.C. DUCT CONSTRUCTION STANDARDS. - METAL AND FLEXIBLE", LATEST

# 1.24. ELECTRIC MOTORS AND WIRING

CONNECTED BY THE CONTROL TRADE.

MOTORS FOR THIS PROJECT.

APPLICABLE CODES.

**FOUIPMENTS PIPING OR DUCTWORK** 

- 1.24.1. SUPPLY ALL MECHANICAL EQUIPMENT WITH ELECTRIC MOTORS AS REQUIRED.
- 1.24.2. THE ELECTRICAL SUBCONTRACTOR SHALL BE RESPONSIBLE TO SUPPLY ALL MOTOR STARTERS AND DISCONNECT SWITCHES, ALL LINE VOLTAGE WIRING TO STARTERS AND STARTERS TO MOTORS EXCEPT ON PRE-WIRED PACKAGED EQUIPMENT FOR ALL
- 1.24.3. CONTROLS (FAN SWITCHES) CONNECTED TO MECHANICAL EQUIPMENTS SHALL BE SUPPLIED BY THE MECHANICAL TRADE AND SHALL BE INSTALLED, WIRED IN AND
- 1.24.4. CONFIRM ELECTRICAL SERVICE VOLTAGE AND PHASE WITH ELECTRICAL ENGINEER, AND/OR CONTRACTOR PRIOR TO ORDERING OF MECHANICAL EQUIPMENT.
- 1.24.5. ALL MOTORS SUPPLIED WITH MECHANICAL EQUIPMENT SHALL OPERATE AT A MAXIMUM OF 1,750 RPM UNLESS OTHERWISE NOTED. REFER TO DIVISION 16 OR 26 DOCUMENTATION FOR AVAILABLE VOLTAGE/PHASE AND CYCLE INFORMATION.

# 5. FIRE PROTECTION

OR SURROUNDINGS

- 1.25.1. FIRE EXTINGUISHERS (TO BE SUPPLIED BY THIS CONTRACTOR AND INSTALLED AS DIRECTED BY LOCAL INSPECTION AUTHORITY); MULTI-PURPOSE ABC, DRY CHEMICAL WITH RECHARGEABLE CYLINDER, HOSE, SHUT-OFF NOZZLE, PRESSURE GAUGE AND MOUNTING BRACKETS. REFER TO LATEST VERSION OF NFPA 10 FOR FIRE EXTINGUISHER
- 1.25.2. FIRE PROTECTION EQUIPMENT AND INSTALLATION SHALL BE APPROVED BY THE PROVINCIAL AND LOCAL FIRE COMMISSIONERS, AS WELL AS THE OWNER'S INSURANCE

TYPE, MINIMUM UL RATING REQUIREMENT, SIZE AND SPACING REQUIREMENTS.

- 1.25.3. THE INSTALLATION IS TO CONFORM TO: N.F.P.A. AND F.M. REGULATIONS AND PAMPHLETS APPLICABLE TO THIS PROJECT, PROVINCIAL AND MUNICIPAL CODES, AND AUTHORITIES HAVING JURISDICTION.
- 1.25.4. EXTEND ALL DRAINS TO THE NEAREST AVAILABLE FLOOR/HUB DRAIN. RUN AUXILIARY DRAINS TO A POINT ACCEPTABLE TO THE AUTHORITIES HAVING JURISDICTION AND THE ENGINEER/OWNER. ALL DRAINS SHALL BE EQUIPPED WITH A SHUT-OFF VALVE, NIPPLE, AND CAP. DRAINS SHALL NOT DISCHARGE TO THE OUTSIDE WITHOUT PRIOR WRITTEN APPROVAL OF THE ENGINEER/OWNER. WHERE NECESSARY, EXTEND OUT FROM BUILDING SUCH THAT THEY SHALL BE LOCATED TO PREVENT DAMAGE TO THE BUILDING
- 1.25.5. DEVIATIONS FROM THE REVIEWED SHOP DRAWINGS, FOR THE PURPOSE OF CO-ORDINATION WITH OTHER WORK, SHALL NOT CONSTITUTE ANY CHANGE TO THE



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# Date Description
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KILDONAN CROSSING 1616 REGENT AVE W WINNIPEG, MB R2C 5C6

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### PLUMBING

#### GENERAL

- ALL SANITARY SEWERS SHALL HAVE A MINIMUM SLOPE OF 1% FOR LINES 100mm (4"Ø) AND OVER. FOR LINES 75mm (3"Ø) AND UNDER USE MINIMUM 2% SLOPE.
- 2.1.2. PLUMBING INSTALLATION SHALL COMPLY WITH LOCAL BUILDING REGULATIONS. SUCH REQUIREMENTS SHALL HAVE PRECEDENCE OVER THE DRAWINGS AND SPECIFICATIONS.
- ALL PIPES SHALL BE LOCATED AWAY FROM AND PROTECTED FROM DAMAGE BY LOAD
- PROVIDE APPROVED BACKFLOW OR SIPHON PREVENTION DEVICES ON PLUMBING LINES WHERE CONTAMINATION OF POTABLE DOMESTIC WATER MAY OCCUR. THESE DEVICES SHALL BE GENERALLY PROVIDED FOR JANITOR'S SINKS, HOSE BIBBS, FIRE PROTECTION SYSTEMS, IRRIGATION SYSTEMS AND WHERE REQUIRED BY CODE. PROTECTION DEVICES SHALL COMPLY WITH CSA B64. PROVIDE BACKFLOW TEST REPORTS TO
- 2.1.5. ALL EXPOSED DRAINAGE PIPING CONNECTED TO PLUMBING FIXTURES IN FINISHED AREAS SHALL BE CHROME PLATED.
- ALL EXPOSED WATER PIPING CONNECTED TO PLUMBING FIXTURES IN FINISHED AREAS TO BE CHROME PLATED.

#### PIPE AND PIPE FITTINGS

- THIS SECTION IS TO BE READ IN CONJUNCTION WITH THE FIRE STOPPING SECTION OF THIS SPECIFICATION. ENSURE AN APPROPRIATE FIRE STOPPING PENETRATION EXISTS FOR ALL MATERIAL TYPES AND SIZES.
- DRAINAGE AND VENT PIPING ABOVE GRADE SHALL BE DWV COPPER OR CAST IRON WITH MECHANICAL JOINTS.
- SANITARY DRAINS 40mm (1 1/2"Ø) AND SMALLER MAY BE HARD TEMPERED COPPER DRAINAGE TUBE (DWV). INSTALL CHROME PLATE WHERE EXPOSED.
- SYSTEM 15 DWV PIPING MAY BE USED FOR APPLICATIONS WHERE A FLAME SPREAD RATING OF NOT MORE THAN 25 IS REQUIRED AND INSTALLED IN STRICT COMPLIANCE
- SYSTEM XFR DWV PIPING MAY BE USED FOR APPLICATIONS WHERE A FLAME SPREAD AND SMOKE DEVELOPMENT RATING OF NOT MORE THAN 25 AND 50 RESPECTIVELY IS REQUIRED AND INSTALLED IN STRICT COMPLIANCE WITH LOCAL CODES AND BYLAWS. LIMITED FIRE STOPPING DETAILS EXIST FOR XFR PIPING, ENSURE THAT THERE IS AN APPROPRIATE ULC/cUL LISTED FIRE STOPPING DETAIL FOR EACH PENETRATION PRIOR TO TENDER CLOSE.
- 2.2.6. DOMESTIC WATER PIPING (DCW, DHW, DHWR) ABOVE GRADE SHALL BE TYPE 'L' HARD COPPER WITH WROUGHT COPPER, BRONZE OR CAST BRASS FITTINGS JOINED WITH 95-5 "LEAD FREE" SOLDER. ALL PIPING SHALL MEET THE APPROVAL OF LOCAL CODES AND AUTHORITIES HAVING JURISDICTION.
- HEATING WATER, AND CHILLED WATER SUPPLY AND RETURN PIPING SHALL BE TYPE 'L' HARD COPPER WITH WROUGHT COPPER, BRONZE OR CAST BRASS FITTINGS JOINED WITH 95-5 "LEAD FREE" SOLDER OR SCHEDULE 40, STEEL PIPING TO ASTM A53, GRADE B.
- 2.2.8. LONGEST POSSIBLE LENGTHS OF COPPER SHOULD BE UTILIZED TO MINIMIZE JOINTS ON
- JOINTS IN COPPER PIPE SHALL BE SOLDERED OR BRAZED. BOTH APPLICATIONS SHALL BE CARRIED OUT TO THE REQUIREMENTS OF THE LOCAL CODE AND AS PER THE CANADIAN COPPER AND BRASS DEVELOPMENT ASSOCIATION RECOMMENDATIONS. INSTALL AS PER THE FOLLOWING PROCEDURES:
- 2.2.9.a. REAM ENDS OF PIPES AND TUBES AND REMOVE BURRS. BEVEL PLAIN ENDS
- OF STEEL PIPE. 2.2.9.b. REMOVE SCALE, SLAG, DIRT AND DEBRIS FROM INSIDE AND OUTSIDE OF PIPE FITTINGS BEFORE ASSEMBLY
- 2.2.9.c. SOLDER JOINTS: APPLY ASTM B813, WATER-FLUSHABLE FLUX, UNLESS OTHERWISE INDICATED TO TUBE END. CONSTRUCT JOINTS ACCORDING TO ASTM B828 OR CDA'S "COPPER TUBE HANDBOOK", USING LEAD-FREE SOLDER
- ALLOY COMPLYING WITH ASTM B32. BRAZED JOINTS: CONSTRUCT JOINTS ACCORDING TO AWS'S "BRAZING HANDBOOK", "PIPE AND TUBE" CHAPTER, USING SIL-FOS 15 BRAZING FILLER METAL COMPLYING WITH AWS A5.8.
- 2.2.10. THREADED JOINTS: THREAD PIPE WITH TAPERED PIPE THREADS ACCORDING TO ASME B1.20.1. CUT THREADS FULL AND CLEAN USING SHARP DIES. REAM THREADED PIPE ENDS TO REMOVE BURRS AND RESTORE FULL ID. JOIN PIPE FITTINGS AND VALVES AS
  - 2.2.10.a. APPLY APPROPRIATE TAPE OR THREAD COMPOUND TO EXTERNAL PIPE THREADS UNLESS DRY SEAL THREADING IS SPECIFIED.
  - 2.2.10.b. DAMAGED THREADS: DO NOT USE PIPE OR PIPE FITTINGS WITH THREADS THAT ARE CORRODED OR DAMAGED. DO NOT USE PIPE SECTIONS THAT HAVE CRACKED OR OPEN WELDS.
- WELDED JOINTS: CONSTRUCT JOINTS ACCORDING TO AWS D10.12, USING QUALIFIED PROCESSES AND WELDING OPERATORS ACCORDING TO PART 1 "QUALITY ASSURANCE"
- 2.2.12. FLANGED JOINTS: SELECT APPROPRIATE GASKET MATERIAL, SIZE, TYPE AND THICKNESS
- FOR SERVICE APPLICATION. INSTALL GASKET CONCENTRICALLY POSITIONED. USE SUITABLE LUBRICANTS ON BOLT THREADS.
- PIPE AND FITTINGS ACCORDING TO THE FOLLOWING:

2.2.13. PLASTIC PIPING SOLVENT-CEMENT JOINTS: CLEAN AND DRY JOINING SURFACES. JOIN

- 2.2.13.a. COMPLY WITH ASTM F402, FOR SAFE-HANDLING PRACTICE OF CLEANERS, PRIMERS, AND SOLVENT CEMENTS.
- 2.2.13.b. ABS PIPING: JOIN ACCORDING TO ASTM D2235 AND ASTM D2661 APPENDIXES. 2.2.13.c. CPVC PIPING: JOIN ACCORDING TO ASTM D2846/D2846M APPENDIX.
- 2.2.13.d. PVC PRESSURE PIPING: JOIN SCHEDULE NUMBER ASTM D1785, PVC PIPE AND PVC SOCKET FITTINGS ACCORDING TO ASTM D2672. JOIN OTHER-THAN-SCHEDULE-NUMBER PVC PIPE AND SOCKET FITTINGS
- 2.2.13.e. PVC NONPRESSURE PIPING: JOIN ACCORDING TO ASTM D2855. 2.2.13.f. PVC TO ABS NONPRESSURE TRANSITION FITTINGS: JOIN ACCORDING TO ASTM

ACCORDING TO ASTM D2855.

- 2.2.14. PLASTIC PRESSURE PIPING GASKETTED JOINTS: JOIN ACCORDING TO ASTM D3139.
- 2.2.15. PLASTIC NONPRESSURE PIPING GASKETTED JOINTS: JOIN ACCORDING TO ASTM D3212.
- 2.2.16. PROVIDE PIPE SLEEVES FOR ALL PIPING PASSING THROUGH FLOOR SLAB. PIPE SLEEVES WILL PROJECT 50mm (2") ABOVE FINISHED FLOOR LEVEL AND BE CAULKED TO MAKE WATER TIGHT PENETRATION.
- 2.2.17. WHERE DISSIMILAR METALS ARE JOINED OR SUPPORTED, THE PIPING SHALL HAVE NON CONDUCTING TYPE CONNECTIONS OR HANGERS TO PREVENT GALVANIC CORROSION.
- 2.2.18. PROVIDE CHROME PLATED RIGID OR FLEXIBLE SUPPLIES TO ALL PLUMBING FIXTURES WITH STOPS, REDUCERS, AND ESCUTCHEONS SECURELY ATTACHED TO WALL AND/OR FLOOR SURFACE.
- 2.2.19. ALL PLUMBING FIXTURES SHALL BE PROVIDED WITH AN APPROVED CLEAR SILICONE SEALANT AROUND PERIMETER WHERE FIXTURES ATTACH TO WALLS AND/OR FLOORS.
- 2.2.20. PLUMBING FIXTURES SHOWN ON ARCHITECTURAL DRAWINGS AND NOT ON MECHANICAL DRAWINGS SHALL BE SUPPLIED AND INSTALLED BY THE CONTRACTOR WITH ALL NECESSARY PIPING FOR THE COMPLETE OPERATION OF THE FIXTURE. CHECK ALL ARCHITECTURAL DRAWINGS DURING THE TENDERING PERIOD.
- 2.2.21. PROVIDE TRAP PRIMERS, WATTS A200 OR EQUIVALENT, ON ALL FLOOR DRAINS
- 2.2.22. PROVIDE ESCUTCHEON ON ALL EXPOSED PIPING PENETRATIONS THROUGH WALL AND
- 2.2.23. INSTALL APPROVED REDUCED PRESSURE BACKFLOW PREVENTER AFTER WATER METER TO MEET APPLICATION. PROVIDE BACKFLOW TEST REPORT TO ENGINEER.
- 2.2.24. UPON COMPLETION OF THE INSTALLATION OF THE POTABLE WATER SERVICE, FLUSH,

STANDING FOR 24 HOURS. THOROUGHLY FLUSH AGAIN UNTIL AWWA STANDARD IS MET. RETAIN AN INDEPENDENT INSPECTION FIRM TO SUPERVISE / INSPECT THE CHLORINATING AND FLUSHING PROCEDURES AND PERFORM CHEMICAL TESTS AS

CHLORINATE WITH SODIUM HYDROCHLORIDE TO AWWA C-601 SPECIFICATIONS AND LET

#### PIPING CONNECTIONS

REQUIRED.

- 2.3.1. MAKE CONNECTIONS ACCORDING TO THE FOLLOWING, UNLESS OTHERWISE INDICATED:
  - 2.3.1.a. INSTALL UNIONS, IN PIPING NPS 2 (DN 50) AND SMALLER, ADJACENT TO EACH VALVE AND AT FINAL CONNECTION TO EACH PIECE OF EQUIPMENT.
  - 2.3.1.b. INSTALL FLANGES, IN PIPING NPS 2-1/2 (DN 65) AND LARGER, ADJACENT TO FLANGED VALVES AND AT FINAL CONNECTION TO EACH PIECE OF EQUIPMENT.

DRY PIPING SYSTEMS: INSTALL DIELECTRIC UNIONS AND FLANGES TO

- CONNECT PIPING MATERIALS OF DISSIMILAR METALS.
- 2.3.1.d. WET PIPING SYSTEMS: INSTALL DIELECTRIC COUPLING AND NIPPLE FITTINGS TO CONNECT PIPING MATERIALS OF DISSIMILAR METALS.

#### PIPE INSULATION

- ALL COVERINGS SHALL BE APPLIED IN A WORKMANLIKE MANNER BY A RED SEAL JOURNEYMAN INSULATION MECHANIC TO PRESENT A NEAT AND CLEAN APPEARANCE AT COMPLETION OF THE WORK TO THE SATISFACTION OF THE ENGINEER. INSULATION ASSEMBLIES SHALL COMPLY WITH CURRENT EDITION OF THE NATIONAL BUILDING REGULATIONS WITH FLAME SPREAD AND SMOKE DEVELOPED RATINGS NOT EXCEEDING 25 AND 50 RESPECTIVELY.
- PROVIDE INSULATION AND ALL SERVICE JACKET (ASJ) FOR
- 2.4.2.A. CONDENSATE LINES, 2.4.2.B. DOMESTIC COLD WATER LINES, 2.4.2.C. CHILLED WATER LINES.
- PROVIDE INSULATION C/W VAPOR BARRIER AND ALL SERVICE JACKET (ASJ) FOR: 2.4.3.A. DOMESTIC HOT WATER LINES,
- HEATING WATER LINES.

2.4.4.a.b. 1" FOR PIPE SIZES 1 1/4"Ø AND SMALLER.

2.4.4. PIPE INSULATION SHALL BE AS PER ASHRAE 90.1-2010 TABLE 6.8.3A AND 6.8.3B.

DOMESTIC HOT WATER RE-CIRCULATION LINES, AND

- 2.4.4.a. FLUID OPERATING TEMPERATURES BETWEEN 105°F AND 140°F ARE TO HAVE A PIPE INSULATION THICKNESS OF; 2.4.4.a.a. 1-1/2" FOR PIPES SIZES 1 1/2"Ø AND LARGER.
- 2.4.4.b. FLUID OPERATING TEMPERATURES BETWEEN 141°F AND 200°F ARE TO HAVE A PIPE INSULATION THICKNESS OF: 2.4.4.a.a. 2" FOR PIPES SIZES 1 1/2"Ø AND LARGER.
- 2.4.4.b. FLUID OPERATING TEMPERATURES BETWEEN 40°F AND 60°F ARE TO HAVE A PIPE INSULATION THICKNESS OF; 2.4.4.a.a. 1/2" FOR PIPES SIZES 1 1/4"Ø AND SMALLER.

2.4.4.a.b. 1 1/2" FOR PIPE SIZES 1 1/4"Ø AND SMALLER.

2.4.4.a.b. 1" FOR PIPE SIZES 1 1/2"Ø AND LARGER. FINISH INSULATION NEATLY AT HANGERS, SUPPORTS AND OTHER PROTRUSIONS.

INSULATE FITTINGS AND VALVES.

- PROVIDE INSULATION AND COVERS IN ACCORDANCE WITH AUTHORITIES GOVERNING COMBUSTIBILITY AND FIRE PROOFING OF MATERIALS, AS PER MANUFACTURER'S RECOMMENDATIONS AND INSTRUCTIONS.
- PROVIDE NON COMBUSTIBLE INSULATION, JACKETS AND FINISHES HAVING A FLAME SPREAD/ SMOKE DEVELOPED RATING OF 25/50 OR LESS, MEETING CAN/ULC S-102
- INSULATE FITTINGS WITH FABRICATED MITERED OR PREFORMED SECTIONS OF SPECIFIED INSULATION.
- 2.4.9. ALL DOMESTIC WATER (DCW, DHW, DHWR) PIPING IS TO BE INSULATED THE FULL LENGTH.
- 2.4.10. PIPE INSULATION SHALL MEET OR EXCEED THE REQUIREMENTS OF ASHRAE 90.1-2010.
- 2.4.11. ALL HEATING WATER (HWS/HWR) PIPING IS TO BE INSULATED THE FULL LENGTH.

2.4.12. ALL CONDENSATE (CND) PIPING IS TO BE INSULATED THE FULL LENGTH.

- 2.4.13. WHERE FIBERGLASS PIPE INSULATION IS USED, INSULATE ALL PIPE FITTINGS. ELBOWS. ETC. WITH PREFORMED FIBROUS GLASS INSULATION FITTINGS OR INSULATING CEMENT, TO THE SAME THICKNESS AS ADJACENT INSULATION. PIPE ELBOWS AND PIPE FITTINGS ON ALL EXPOSED INSULATION SHALL BE COVERED WITH PVC FITTING COVERS, OR
- 2.4.14. WHERE PIPING IS SUPPORTED AT EXTERIOR SURFACE OF INSULATION PROVIDE 300mm (12") LONG, SUPPORT SHIELD WITH HIGH DENSITY INSULATION UNDER SHIELD, AT EACH

### **CLEANOUTS**

2.5.

- PROVIDE AND SET CLEANOUTS AT ALL POINTS REQUIRED BY CODES AND WHERE INDICATED ON THE DRAWINGS, ALL CLEANOUTS SHALL BE MADE ACCESSIBLE BY EXTENDING BRANCH CONNECTIONS TO FINISHED SURFACE AND FITTING THEM WITH A SUITABLE ACCESS COVER TO ACCEPT FLOOR FINISH.
- 2.5.2. CLEANOUTS IN CONCRETE SHALL BE ADJUSTABLE TYPE FOR LEVEL INSTALLATION.
- 2.5.3. CLEANOUTS IN UNFINISHED AREAS SHALL BE WATTS CO-200-R OR EQUAL.
- 2.5.4. CLEANOUTS IN FINISHED AREAS SHALL BE WATTS CO-1200-R OR EQUAL.

### 2.6.

- VALVES SHALL BE INSTALLED AS INDICATED ON THE DRAWINGS, AS SPECIFIED, AND AS REQUIRED TO ISOLATE ALL FIXTURES, EQUIPMENT, ETC.
- PROVIDE ALL VALVES AS SHOWN ON THE DRAWINGS OR REQUIRED BY LOCAL BUILDING CODES AND AUTHORITIES HAVING JURISDICTION.
- 2.6.3. USE BALL VALVES ON ALL DOMESTIC WATER PIPING, 2" (50mm) OR LESS IN DIAMETER.
- PROVIDE BRONZE TYPE BALL VALVES ON MAIN AND BRANCH LINES AND ISOLATION VALVES FOR EACH PLUMBING FIXTURE SERVED.
- ALL ISOLATION VALVES INSTALLED FOR SHUT-OFF PURPOSES TO BE RED AND WHITE
- #5044A BALL VALVES, UNLESS OTHERWISE SPECIFIED.

2.6.6. HYDRONIC HEATING - CONTROL VALVES ARE TO FAIL OPEN.

ALL VALVES COMPLETE WITH DRAIN AND CAP ARE TO HAVE THE VALVE HANDLE

# PLUMBING FIXTURES

- 2.7.1. ALL FIXTURES SHALL BE FREE FROM FLAWS OR BLEMISHES AND SUBJECT TO APPROVAL. ALL FINISHED SURFACES SHALL BE CLEAR, SMOOTH AND BRIGHT AND GUARANTEED NOT TO CRAZE, COLOR OR SCALE.
- FIXTURE SUPPORT MUST BE SUCH THAT THEY WILL NOT COME LOOSE WITH ORDINARY USAGE AND THAT ANCHORING WILL BE RIGID. REINFORCE WALL BEHIND FIXTURES IF REQUIRED FOR PROPER SUPPORT.
- 2.7.3. REFER TO FIXTURE SCHEDULE ON DRAWINGS.

2.7.5. ALL PLUMBING FIXTURES MUST BE CSA APPROVED.

WHEELCHAIR ACCESSIBLE LAVATORY P-TRAP AND ANGLE VALVE ASSEMBLIES SHALL BE COVERED WITH THE MOLDED, ANTI-MICROBIAL TRUEBRO, INC. LAVATORY GUARD, UNDER SINK PROTECTIVE PIPE COVER ACCESSORY, COLOR WHITE, COVER SHALL BE SECURED WITH SNAP CLIP FLUSH, RE-USABLE FASTENERS, ANGLE STOP SHALL HAVE LOCK-LID LOCKING ACCESS COVERS.

- 2.7.6. CONTRACTOR TO PROVIDE THREE (3) EACH OF THE FOLLOWING SPARE PARTS;
  - WATER CLOSET FILL VALVE ASSEMBLY. KITCHEN FAUCET MIXING VALVE AND TRIM KIT.

BATHROOM FAUCET MIXING VALVE AND TRIM KIT.

### DOMESTIC HOT WATER SYSTEM

TEMPERATURE IN ALL TANKS TO BE 140°F (60°C).

VENTED, AND COMPLETELY STARTED.

#### PIPING SYSTEMS CLEANING AND CHEMICAL TREATMENT

- PROVIDE FOR FLUSHING AND DISINFECTION OF ENTIRE DOMESTIC WATER
- MAKE SYSTEMS COMPLETELY OPERATIONAL, TOTALLY FILLED, THOROUGHLY
- ALL DOMESTIC HOT, COLD AND DOMESTIC RECIRCULATION WATER SYSTEMS WILL BE REQUIRED TO BE THOROUGHLY FLUSHED WITH POTABLE WATER TO CLEAN. COLLECT AND LABEL WITH COLLECTION LOCATION FOUR (4) POTABLE WATER TEST SAMPLES FROM THE MOST REMOTE FIXTURES IN THE BUILDING (FROM HOT WATER TAP AND COLD-WATER TAP) AND FROM A FIXTURE MIDWAY THROUGH THE BUILDING (FROM HOT WATER TAP AND COLD WATER TAP), OR, AT LOCATIONS AS DIRECTED BY THE ENGINEER. HAVE SAMPLES TESTED AND SUBMIT TEST RESULTS TO ENGINEER FOR REVIEW.
- IF TESTING INDICATES CONTAMINATION, IF REQUIRED BY THE ENGINEER, OR, IF REQUIRED BY THE AHJ, DISINFECT DOMESTIC HOT, COLD AND DOMESTIC RECIRCULATION WATER SYSTEMS. ADD CHLORINE TO WATER IN SYSTEM TO 50 PPM AND LET STAND FOR 24 HOURS. CHECK CHLORINE CONTENT AFTER 24 HOURS AND INSURE THE CONTENT IS NOT LESS THAN 20PPM. IF LESS THAN 20PPM REPEAT PROCESS. FLUSH SYSTEM UNTIL THE CHLORINE CONTENT OF WATER BEING DRAINED IS EQUAL TO THE CHLORINE CONTENT OF THE MAKE-UP WATER. UTILIZE PLUMBING FIXTURES (I.E. LAV, SINKS, FLUSHOMETERS, ETC.) FOR DRAINAGE. RE-TEST UP TO FOUR (4) ADDITIONAL SAMPLES AS DIRECTED BY THE ENGINEER.
- IF DISINFECTION PROCEDURES ARE NOT SUCCESSFUL, RETAIN AN INDEPENDENT INSPECTION FIRM TO SUPERVISE / INSPECT THE CHLORINATING AND FLUSHING PROCEDURES AND PERFORM CHEMICAL TESTS AS REQUIRED.
- UPON COMPLETION OF THE INSTALLATION OF THE BELOW GRADE POTABLE WATER SERVICE, FLUSH, CHLORINATE WITH SODIUM HYDROCHLORIDE TO AWWA C-601 SPECIFICATIONS AND LET STANDING FOR 24 HOURS. THOROUGHLY FLUSH AGAIN UNTIL AWWA STANDARD IS MET.



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G.L. SMITI

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PROJECT TITLE:

REVISION



KILDONAN CROSSING 1616 REGENT AVE \ WINNIPEG, ME R2C 5C6 CRU # 4

DRAWING TITLE: **SPECIFICATIONS** 

PRINT DATE: 2023-05-18 DRAWN BY: TW

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### HVAC

#### DUCTWORK

- DUCTWORK SHALL BE GALVANIZED STEEL AND SHALL BE LOCK FORMING QUALITY. ALL DUCTWORK SHALL BE CONSTRUCTED, BRACED, CONNECTED AND JOINTED AS RECOMMENDED IN THE LATEST ISSUE OF ASHRAE GUIDE AND THE DUCT CONSTRUCTION STANDARDS ISSUED BY THE SHEET METAL NATIONAL ASSOCIATION INC. (SMACNA). ALL DUCTWORK SHALL BE INSTALLED TO CONFORM TO THE MOST CURRENT EDITION OF THE ALBERTA BUILDING CODE, NFPA PAMPHLETS 90A AND 91 AND IN ACCORDANCE WITH APPLICABLE CODES.
  - THE MINIMUM SHEET METAL THICKNESS FOR DUCTS SHALL BE 28 GAUGE, 30 GAUGE DUCT THICKNESS WILL NOT BE PERMITTED.
  - THE USE OF SNAP LOCK DUCTWORK IS NOT PERMITTED.
  - DUCTWORK IS TO BE CONSTRUCTED AND GAUGE SELECTED BASED ON SYSTEM STATIC PRESSURE REQUIREMENTS, JOINT TYPE, REINFORCEMENT TYPE AND REINFORCING SPACING.
- 3.1.1.D. RECTANGULAR DUCTS ARE TO BE COMPLETE WITH CROSSBREAKING OR BEADING WHERE REQUIRED.
- DUCT SIZES SHOWN ARE SHEET METAL SIZES, WHERE INTERNAL INSULATION IS SPECIFIED MAKE AN ALLOWANCE FOR INSULATION THICKNESS. MAINTAIN INTERNAL DUCT SIZES SHOWN. PRIOR TO FABRICATION, CHECK CEILING SPACES, HEIGHTS AND CONFLICTS, WITH OTHER TRADES AT THE SITE AND OFF DRAWINGS. PROVIDE ADDITIONAL OFFSETS AND CHANGES IN DIRECTION REQUIRED, WITHOUT ADDITIONAL
- DUCTS SHALL NOT, UNDER ANY CIRCUMSTANCES, BE SUPPORTED BY MEANS OF PERFORATED BAND IRON, WIRE OR CHAIN. DUCTS SHALL NOT BE SUPPORTED FROM HANGERS SUPPLIED BY OTHER TRADES.
- 3.1.4. ROUND DUCTWORK SHALL BE SUSPENDED BY BAND IRON HANGERS.
- 3.1.5. RECTANGULAR DUCTWORK SHALL BE SUPPORTED AT MAXIMUM 2.4m (7'-10") SPACING.
- FLEXIBLE DUCTWORK SHALL BE FLEXMASTER MODEL FAB5M OR THERMAFLEX TYPE
- FLEXIBLE DUCTWORK ALUMINUM HELICALLY WOUND, INSULATED AND ULC LISTED. MAXIMUM LENGTH IS TO BE 1m (3'-0") AT FINAL CONNECTION TO DIFFUSERS.
- ALL EXPOSED DUCTWORK IS TO BE INTERNALLY SEALED AT DUCT CONNECTIONS TO PROVIDE A CLEAN FINISH. ALL JOINTS ARE TO BE CLEANED PRIOR TO JOB COMPLETION.
- DUCTS TO BE GALVANIZED STEEL LOCK FORMING QUALITY, HAVING GALVANIZED COATING TO ASTM A525 C90 DESIGNATION FOR BOTH SIDES.
- 3.1.10. FASTENERS TO BE SHEET METAL SCREWS ON LOW PRESSURE DUCTS.
- SEALANT: OIL RESITANT, WATER RESISTANT, FIRE RESISTIVE, COMPATIBLE WITH ADJACENT MATERIALS. ALL DUCT JOINTS ARE TO BE SEALED WITH SEALANT.
- 3.1.12. RIGIDLY CONSTRUCT METAL DUCTS WITH PROPRIETARY PRE-MANUFACTURED DUCT JOINING SYSTEM MECHANICALLY TIGHT, SUBSTANTIALLY AIR TIGHT, BRACED AND STIFFENED SO AS NOT TO BREATHE, RATTLE, VIBRATE OR SAG.
- PROPRIETARY PRE-MANUFACTURED DUCT JOINING SYSTEM SHALL BE CONSTRUCTED IN ACCORDANCE WITH THE LATEST EDITIONS OF ASHRAE AND SMACNA GUIDLINES. DUCT CONNECTION SYSTEM SHALL CONSIST OF ROLL-FORMED FLANGES, CORNER PIECES, GASKETS AND CLEATS. FLANGES ARE USED TO ATTACH TO DUCT WALL WITH INTEGRAL MASTIC THAT ALLOW FLANGE TO SEAL ITSELF TO THE DUCT. CORNER PIECE ARE USED TO ADD RIGIDITY TO THE FLANGE, HOLD THE DUCTWORK TOGETHER AND PROVIDE A SEALING SURFACE FOR THE GASKET. THE GASKET SHALL MAKE AN AIR TIGHT SEAL BETWEEN THE FLANGES. THE CLEAT ENSURES EVEN COMPRESSION OF THE GASKET ALONG THE LENGTH OF THE FLANGE.
- 3.1.14. ALL HANGERS SHALL BE 1/4" (6mm) RODS AND 1"x1"x1/4"(25x25x6mm) ANGLES.
- 3.1.15. INSTALL BREAKAWAY JOINTS IN DUCTWORK ON SIDES OF FIRE SEPARATION.
- 3.1.16. DUCT CONNECTIONS AT FAN COIL UNITS, HRV'S ETC. SHALL BE MADE WITH 150mm (6") LONG FLEXIBLE NEOPRENE, TO PREVENT TRANSMISSION OF VIBRATION. THE CONTRACTOR SHALL ENSURE THAT ALL CONNECTIONS ARE LEAKPROOF.
- ALL DUCTS ASSOCIATED WITH FANS AND OTHER MACHINERY SHALL BE FITTED WITH CANVAS FLEXIBLE CONNECTIONS AT INLET AND OUTLET.

#### **DUCT INSULATION** 3.2.

- ALL COVERINGS SHALL BE APPLIED IN A WORKMANLIKE MANNER BY A RED SEAL JOURNEYMAN INSULATION MECHANIC TO PRESENT A NEAT AND CLEAN APPEARANCE AT COMPLETION OF THE WORK TO THE SATISFACTION OF THE ENGINEER INSULATION. ASSEMBLIES SHALL COMPLY WITH CURRENT EDITION OF ALBERTA BUILDING REGULATIONS WITH FLAME SPREAD AND SMOKE DEVELOPED RATINGS NOT EXCEEDING 25 AND 50 RESPECTIVELY.
- APPLY 25mm (1") THICK INTERNAL ACOUSTIC INSULATION ON SUPPLY, RETURN, AND EXHAUST AIR DUCTWORK WHERE SHOWN BY CROSS HATCHING OF DUCTWORK ON THE
- APPLY 25mm (1") THICK FLEXIBLE FIBROUS GLASS EXTERNAL THERMAL INSULATION WITH FACTORY APPLIED VAPOUR BARRIER ON SUPPLY AND RETURN AIR DUCTWORK.
- APPLY 50mm (2") THICK FLEXIBLE FIBROUS GLASS INSULATION WITH FACTORY APPLIED REINFORCED VAPOUR BARRIER ON COMBUSTION AND OUTSIDE AIR INTAKE DUCTWORK.
- INSULATE ALL DUCTWORK LOCATED OUTDOORS OR SUBJECT TO OUTDOOR TEMPERATURE WITH 50mm (2") THICK, RIGID FIBERGLASS, MOISTURE RESISTANT INTERNAL DUCT INSULATION. MINIMUM R-8 THERMAL VALUE. ENSURE ALL SEAMS AND JOINTS ARE SEALED WATERTIGHT.
- INSULATE VENTILATION EQUIPMENT AND CABINET EXHAUST FAN CASINGS WITH 25mm (1") THICK RIGID FIBERGLASS INTERNAL DUCT INSULATION. INSULATION TO BE FACTORY
- ALL SUPPLY AND RETURN DUCTWORK SHALL BE LINED WITH 25mm (1") THICK INTERNAL ACOUSTIC INSULATION MINIMUM 3m (10 FEET) FROM EXTERIOR PENETRATION.
- INSULATE THE FIRST 3m (10'-0") OF EXHAUST DUCTWORK FROM THE ROOF OR WALL TERMINAL WITHIN THE BUILDING WITH 1" THICK FLEXIBLE, FOIL FACED FIBERGLASS OR CANVAS EXTERIOR INCLUDING THE ATTIC SPACES. INSULATE ALL DUCTWORK FULL
- INSULATION TO BE 25mm (1") THICK MINERAL FIBRE WITH VAPOUR BARRIER. INSULATE ALL SUPPLY AIR DUCTWORK. INSULATE EXHAUST DUCTWORK FOR A DISTANCE OF 1.5m (5'-0") UPSTREAM OF FAN.
- ALL ADHESIVES, MASTICS, SEALANTS AND COATINGS USED INSIDE THE BUILDING WITH THE INSULATION SHALL BE FIRE RETARDING AND MEET ULC STANDARDS AND ALBERTA BUILDING CODE WITH A FLAME SPREAD RATING OF NOT OVER 25 AND SMOKE DEVELOPED CLASSIFICATION NOT OVER 50.

#### 3.3. VOLUME DAMPERS

3.3.1. INSTALL WHERE REQUIRED FOR BALANCING.

LENGTH RUNNING IN COLD SPACES.

- RECTANGULAR DUCTS SHALL HAVE OPPOSED BLADE VOLUME DAMPERS.
- ROUND DUCTS SHALL HAVE SPLITTER DAMPERS OR BUTTERFLY DAMPERS.
- HAND BALANCING DAMPERS SHALL BE FABRICATED OF GALVANIZED IRON, TWO GAUGES HEAVIER THAN THAT OF THE DUCT IN WHICH THE DAMPER IS TO BE INSTALLED.

#### **ACCESS** 3.4.

ACCESS SHALL BE PROVIDED TO ALL MECHANICAL EQUIPMENT. BALANCING DAMPERS. VALVES AND ALL OTHER ITEMS REQUIRING SERVICING ACCESS. ACCESS PANELS SHALL BE FIRE-RATED AS REQUIRED, TO MEET CEILING, WALL AND FLOOR RATINGS.

#### AIR OUTLETS 3.5.

PROVIDE ALL AIR OUTLETS COMPLETE WITH ACCESSORIES AS SPECIFIED HEREIN AND INDICATED ON THE DRAWINGS. COORDINATE LOCATIONS OF ALL AIR

CONTRACTOR SHALL CHECK THE LOCATION OF ALL OUTLETS AND SHALL MAKE SUCH ADJUSTMENTS IN POSITION AS NECESSARY TO CONFORM WITH ARCHITECTURAL FEATURES AT NO EXTRA COST TO OWNER.

OUTLETS WITH LIGHTING. THE POSITIONS INDICATED ARE APPROXIMATE ONLY. THIS

- VIBRATION ISOLATION REQUIREMENTS
- MOUNT MECHANICAL EQUIPMENT ON VIBRATION ISOLATORS TO MINIMIZE THE RANSMISSION OF VIBRATION TO BUILDING STRUCTURE.
- PROVIDE FLEXIBLE PIPE SECTIONS IN PIPING TO PREVENT THE TRANSMISSION OF VIBRATION TO THE BUILDING STRUCTURE.
- INSTALL FLEXIBLE DUCT CONNECTIONS AT AIR HANDLING UNITS, SUPPLY AND EXHAUST FANS TO PREVENT VIBRATION TRANSMISSION TO DUCTWORK.

#### AIR SYSTEM TESTING, BALANCING AND COMMISSIONING

- AIR BALANCING SHALL BE CARRIED OUT BY AN INDEPENDENT AGENCY, REGISTERED WITH ASSOCIATED AIR BALANCE COUNCIL (AABC), SPECIALIZING IN THIS FORM OF WORK AND IN ACCORDANCE WITH GUIDELINES ESTABLISHED BY THE ASSOCIATED AIR BALANCE COUNCIL (AABC).
- BALANCE SYSTEM FOR RATED AIR FLOW, AIR TEMPERATURE CONTROL AND CURRENT DRAW AFTER INSTALLATION IS COMPLETE AND IN FULL WORKING ORDER. ADJUST CONTROL FOR CONTINUOUS AIR CIRCULATION AND MINIMUM ENERGY CONSUMPTION. ADJUST FAN SPEED AS REQUIRED TO OBTAIN SPECIFIC PERFORMANCES. BALANCE SYSTEM FOR OUTSIDE AIR AS GIVEN IN UNIT PERFORMANCE. FAN SHEAVES SHALL BE ADJUSTED OR REPLACED AS REQUIRED, TO ACHIEVE DESIGN AIR FLOW.
- PRIOR TO OCCUPANCY, BUT AFTER ALL INTERIOR CONSTRUCTION IS SUBSTANTIALLY COMPLETE AND ALL FINISHES HAVE BEEN INSTALLED, PERFORM A FULL SYSTEM FLUSH OF THE AIR WITHIN THE BUILDING BY RUNNING THE AIR HANDLER(S) (ON MAXIMUM SPEED IF A VARIABLE SPEED DEVICE) FOR A MINIMUM OF 48 HOURS (COMBINED OVER NOT MORE THAN 4 SESSION), AND PROVIDE NEW FILTERS IN THE AIR HANDLER(S) AFTER THE FLUSH IS COMPLETE.
- THE MECHANICAL CONTRACTOR SHALL HIRE AND PAY FOR THE EQUIPMENT MANUFACTURER'S REPRESENTATIVE OR QUALIFIED REFRIGERATION MECHANIC TO STARTUP FACH FAN UNIT, CHECK OUT ALL ASSOCIATED CONTROLS AND SAFETY CUTOUTS, THIS INCLUDES THERMOSTATS, UNIT OUTSIDE AIR DAMPERS, FIRE STARTS, EXHAUST FAN INTERLOCKS ETC.. THIS WORK SHALL BE COMPLETE AND ANY DEFICIENCIES RECTIFIED, PRIOR TO NOTIFYING THE BALANCING CONTRACTOR THAT THE SYSTEMS ARE READY TO BE BALANCED.
- 3.7.5. COMMISSION ENTIRE MECHANICAL SYSTEM. INCLUDE START UP REPORT IN MAINTENANCE MANUAL.
- ALL LOW VELOCITY DUCT SYSTEMS, INCLUDING SUPPLY, RETURN AND EXHAUST SHALL BE CHECKED FOR TIGHTNESS. ALL LEAKS SHALL BE REPAIRED BEFORE DUCTS ARE FURRED IN TO ENSURE TOTAL OUTLET CAPACITY IS WITHIN 5% OF THE QUANTITY BEING SUPPLIED BY THE AIR SYSTEMS
- TO OBTAIN SPECIFIED AIR VOLUMES THIS CONTRACTOR SHALL MAKE ALL NECESSARY 3.7.7. BELT AND SHEAVE CHANGES, ADD DAMPERS, VALVES, ETC. AS MAY BE REQUIRED AT NO ADDITIONAL COST TO THE CONTRACT.
- PREPARE AND SUBMIT THREE (3) COPIES OF COMPLETED REPORTS FOR ALL AIR HANDLING SYSTEMS AS PER THE NATIONAL GUIDELINES.
- 3.7.9. TESTING OF LOW VELOCITY DUCTWORK SHALL COMPRISE REPAIRING AND/OR REPLACING ANY AND ALL AUDIBLE LEAKS OR THOSE THAT ARE NOTICEABLE BY FEEL
- MECHANICAL SYSTEMS SHALL NOT BE CONSIDERED READY FOR FINAL INSPECTION UNTIL BALANCING RESULTS ARE ACCEPTABLE TO CONSULTANT

#### GENERAL

- PROVIDE UNITS FROM MANUFACTURERS REGULARLY ENGAGED IN PRODUCTION OF SUCH UNITS AND WHO ISSUE CATALOGUE DATA ON SUCH PRODUCTS.
- ANY EQUIPMENT THAT THE MECHANICAL CONTRACTOR WISHES TO INSTALL AS AN INSTALLATION IF NOT APPROVED BEFORE INSTALLATION THE ENGINEER MAY DEEM IT NECESSARY TO REPLACE THE INSTALLED EQUIPMENT WITH THAT WHICH WAS SPECIFIED AT THE COST OF THE CONTRACTOR.
- 4.1.3. THE EQUIPMENT SPECIFIED IS TO BE MINIMUM STANDARD AND QUALITY REQUIRED, ANY ALTERNATE EQUIPMENT MUST MEET OR EXCEED THE STANDARD AND QUALITY OF THAT WHICH WAS SPECIFIED.
- 4.1.4. ALL ALTERNATES MUST BE SUBMITTED A MINIMUM OF SEVEN (7) DAYS PRIOR TO TENDER CLOSE
- EQUIPMENT ORIENTATION AND AIRFLOW ARRANGEMENT IS TO BE VERIFIED BY THE CONTRACTOR PRIOR TO ORDERING AND INSTALLATION. IF UNITS WITH THESE ARRANGEMENTS AS LAID OUT ARE NOT USED, THE CONTRACTOR IS RESPONSIBLE FOR ANY EXTRA COSTS INCURRED.
- THE EQUIPMENT SUPPLIER(S) SHALL VISIT THE SITE AND INSPECT THE INSTALLATION OF ALL EQUIPMENT. THE SUPPLIER SHALL CONFIRM IN WRITING, TO THE CONSULTANT. THAT THE INSTALLATION AND OPERATION OF THIS EQUIPMENT MEETS SPECIFIED CONDITIONS, AND MANUFACTURER'S INSTALLATION AND OPERATION GUIDELINES.
- WHEN APPLICABLE, THE CONTRACTOR IS TO PUT A LABEL ON THE EQUIPMENT, IN AN EASILY VISIBLE SPACE, WITH RECOMMENDED SET POINTS, BELT SIZES AND FILTER SIZE.

#### DOMESTIC ELECTRIC TANK TYPE WATER HEATERS 4.2.

- VOLTAGE APPLIED TO THE HEATER SHOULD NOT VARY MORE THAN +5% TO -10% OF THE MODEL AND RATING PLATE MARKING FOR SATISFACTORY OPERATION.
- WATER HEATERS SHALL HAVE MINIMUM RATED INPUTS, RECOVERY AND STORAGE CAPACITY NOT LESS THAN LISTED IN THE EQUIPMENT SCHEDULES.
- THE TANK SHALL BE LINED WITH VITRAGLAS ® VITREOUS ENAMEL AND SHALL HAVE A BOLTED HAND HOLE CLEANOUT.
- 4.2.4. THE WATER HEATER SHALL BE EQUIPPED WITH STAINLESS STEEL COLD WATER INLET.
- THE HEATER SHALL BE INSULATED WITH NON CFC FOAM.
- THE WATER HEATER SHALL BE EQUIPPED WITH AN ASME RATED TEMPERATURE AND
- PRESSURE RELIEF VALVE.
- THE WATER HEATER SHALL BE FACTORY ASSEMBLED AND TESTED.
- TEMPERATURE UP TO 140°F (60°C). THE ENTIRE INSTALLATION SHALL BE MADE IN COMPLIANCE WITH PROVINCIAL AND LOCAL CODES AND BYLAWS INCLUDING NFPA 70, THE NATIONAL ELECTRICAL CODE.

THE CONTROL SHALL BE AN ADJUSTABLE ELECTRONIC THERMOSTAT TO ANY

- DESIGN CERTIFIED TO CSA INTERNATIONAL FOR 140°F (60°C) APPLICATION, EITHER WITH OR WITHOUT A SEPARATE STORAGE TANK AND MUST COMPLY WITH PROVINCIAL AND LOCAL CODES INCLUDING NFPA 70, THE NATIONAL ELECTRICAL CODE.
- 4.2.10. PROVIDE MINIMUM 6" CLEARANCE AROUND UNIT FOR ACCESS TO REPLACEABLE PARTS INCLUDING THERMOSTAT, RELIEF AND DRAIN VALVE.
- PROVIDE HEAT TRAPS AT BOTH THE HOT AND COLD WATER CONNECTIONS AS PER THE MOST CURRENT COPY OF ASHRAE 90.1.

### HEATING RECOVERY VENTILATION UNIT

- HRV'S SHALL HAVE MINIMUM RATED INPUTS; AIRFLOW AT STATIC SHOWN, EFFICACY, AND SENSIBLE EFFECTIVENESS NOT LESS LISTED IN THE EQUIPMENT SCHEDULES.
- 4.3.2. COUNTER-FLOW HEAT RECOVERY CORE TRANSFERS HEAT BETWEEN THE TWO

- AIRSTREAMS. EASILY REMOVED FOR CLEANING AND SERVICE.
- 4.3.3. HIGH EFFICIENCY ELECTRONIC COMMUTATED ECM MOTOR. EACH AIR STREAM HAS ONE CENTRIFUGAL BLOWER WITH MULTIPLE FAN SPEED OPERATION DRIVEN BY ONE DOUBLED SHAFT MOTOR.
- 4.3.4. WASHABLE FILTERS
  - THREADED INSERTS AT CORNER OF THE CABINET DESIGNED TO ACCEPT "S" HOOKS AND HANGING STRAPS SUPPLIED WITH THE UNIT.
- 4.3.6. RE-CIRCULATING DAMPER DEFROST SYSTEM 20 GAUGE PRE-PAINTED GALVANIZED STEEL C/W INSULATION TO PREVENT EXTERIOR
- 4.3.8. CONDENSATE DRAIN CONNECTION TO BE LOCATED ON THE UNIT.

OF THE HOME. 2 WIRE 20 GAUGE MIN. 100FT LENGTH MAX FROM UNIT.

CONTROL INCLUDED WITH THE UNIT CAN BE WALL MOUNTED IN A CENTRAL LOCATION

4.3.10.A. 5 SPEED OPERATION ON EACH MODE.

- 4.3.10. CONTROLS
  - 4 USER SELECTABLE OPERATIONAL MODES: CONTINUOUS. 20 ON/40 OFF, 200N/40 RE-CIRCULATION, CONTINUOUS RE-CIRCULATION.

### FAN COIL UNIT

- FAN COILS SHALL HAVE MINIMUM RATED INPUTS; AIRFLOW AT STATIC SHOWN, EFFICIENCY, AND SENSIBLE EFFECTIVENESS NOT LESS LISTED IN THE EQUIPMENT
- SCHEDULES HIGH EFFICIENCY ELECTRONIC COMMUTATED ECM MOTOR. ONE CENTRIFUGAL BLOWER
- WITH MUI TIPLE FAN SPEED OPERATION DRIVEN BY ONE SHAFT MOTOR FAN ASSEMBLY SHALL BE EASILY REMOVABLE FOR SERVICING AND CLEANING.
- THROWAWAY FILTERS. FILTERS SHALL BE EASILY REMOVABLE FROM THE BOTTOM OF THE UNIT WITHOUT THE NEED FOR TOOLS.
- THREADED INSERTS AT CORNER OF THE CABINET DESIGNED TO ACCEPT "S" HOOKS AND HANGING STRAPS SUPPLIED WITH THE UNIT.
- 4.4.6. 20 GAUGE PRE-PAINTED GALVANIZED STEEL C/W INSULATION TO PREVENT EXTERIOR CONDENSATION.
- PRIMARY CONDENSATE DRAIN PANS SHALL BE SINGLE WALL HEAVY GAUGE GALVANIZED STEEL FOR CORROSION RESISTANCE, AND EXTEND UNDER THE ENTIRE COOLING COIL. DRAIN PANS SHALL BE OF ONE PIECE CONSTRUCTION AND BE DOUBLE SLOPED FOR CONDENSATE REMOVAL
- COILS SHALL BE AHRI 410 CERTIFIED AND TAGGED WITH AN AHRI 410 LABEL. COILS SHALL HAVE SEAMLESS COPPER TUBES AND SHALL BE MECHANICALLY EXPANDED TO
- UNITS SHALL BE FURNISHED WITH A SINGLE POINT POWER CONNECTION. PROVIDE AN ELECTRICAL JUNCTION BOX WITH TERMINAL STRIP FOR MOTOR AND OTHER ELECTRICAL TERMINATIONS.

PROVIDE AN EFFICIENT, PERMANENT BOND BETWEEN THE TUBE AND FIN.

- 4.4.10. CONTROLS
  - PROVIDE TERMINAL WIRING BLOCK TO FACILITATE WIRING TERMINATIONS FOR THE ELECTRIC CONTROL VALVES AND THERMOSTATS
  - FAN MOTOR SHALL BE COMPLETE WITH SCR CONTROLLER

# CONTROLS

# GENERAL

- 5.1.1 PROVIDE SYSTEM COMPONENTS CONSISTING OF THERMOSTATS, CONTROL VALVES DAMPERS, OPERATORS, INDICATING DEVICES AND INTERFACE EQUIPMENT AS REQUIRED TO OPERATE MECHANICAL SYSTEM AND TO PERFORM FUNCTIONS
- ALL CONTROLS FOR MECHANICAL EQUIPMENT SHALL BE THE RESPONSIBILITY OF THE MECHANICAL CONTRACTOR. COORDINATE INSTALLATION WITH G.C. AND ELECTRICAL CONTRACTOR WHERE REQUIRED.
- UNLESS OTHERWISE CALLED FOR, WORK SHALL INCLUDE, BUT NOT BE LIMITED TO, THE PROVISION OF THERMOSTATS, CONTROLLERS, OPERATORS, SENSORS, CONTROL VALVES, TRANSFORMERS, INTERFACE EQUIPMENT, CONTROL RELAYS, AND ALL OTHER NECESSARY AUXILIARY DEVICES REQUIRED TO PERFORM FUNCTIONS IN REQUIRED
- THE ELECTRICAL TRADE SHALL SUPPLY AND INSTALL ALL ELECTRICAL LINE VOLTAGE 5.1.4. WIRING AND CONDUIT REQUIRED BY THE MECHANICAL TRADE. MECHANICAL CONTRACTOR IS TO COVER THIS SERVICE IN THEIR FEES.
- INSTALLATION OF CONTROL WORK BY THE ELECTRICAL TRADE SHALL BE DONE UNDER THE SUPERVISION OF THE MECHANICAL TRADE.
- CONTROL WIRING, CONDUIT AND ELECTRICAL DEVICES SHALL COMPLY WITH THE REQUIREMENTS OF DIVISION 16 OR 26 - ELECTRICAL. ALL CONTROL WIRING SHALL BE COLOUR CODED AND TAGGED FOR EASY IDENTIFICATION.
- THERMOSTATS SHALL BE MOUNTED 1.5m (5 FEET) ABOVE THE FLOOR LEVEL AND ON LOCK SIDE OF DOORS. (IF ADJACENT THERETO) VERTICALLY IN LINE WITH THE LIGHT SWITCH, UNLESS OTHERWISE SPECIFIED. THERMOSTATS MOUNTED ON OUTSIDE WALLS SHALL BE STOOD OFF FROM THE WALL BY INSULATED BLOCKS OR BRACKETS WHICH ALLOW FREE AIR MOVEMENT BEHIND THE THERMOSTAT.
- 5.1.8. IT IS THE RESPONSIBILITY OF THE MECHANICAL CONTRACTOR TO ENSURE THAT, ALL CONTROL DEVICES SERVING MECHANICAL EQUIPMENT ARE INSTALLED CORRECTLY AND FUNCTION PROPERLY, AND THAT ALL MECHANICAL EQUIPMENT OPERATES AS DESIGNED AND SPECIFIED, IN CONJUNCTION WITH THE CONTROLS.
- 5.1.9. TAG AUTOMATIC CONTROLS, ELECTRIC SWITCHES, INSTRUMENTS AND RELAYS WITH LAMICOID LABELS WITH 15mm (1/2") LETTERS AND KEY WITH CONTROL SWITCHES.
- 5.1.10. CONTROL FOR ECONOMIZER SECTIONS, ALL OUTDOOR AND RELIEF DAMPERS TO BE ELECTRIC OR DDC. PROVIDE PROGRAMMABLE THERMOSTAT WITH LOCKABLE
- 5.1.11. INSTALL MOTOR DAMPERS ON OUTSIDE OF DUCT, NOT IN AIRSTREAM.

### SEQUENCE OF OPERATIONS

- THE CONTROL SEQUENCES CONTAIN A GENERAL DESCRIPTION OF THE INTENT OF THE OPERATION OF THE SYSTEMS TO BE CONTROLLED. THE CONTRACTOR SHALL REVIEW INDIVIDUAL SYSTEMS TO ENSURE EQUIPMENT AND LIFE SAFETY INTERLOCKS ARE NOT OVERRIDDEN
- CONSULT WITH THE CONSULTANT DURING THE SHOP DRAWING STAGE TO FINALIZE THE CONTROL SEQUENCES AND CONTROL POINTS FOR EACH SYSTEM.
- 5.2.3. PROVIDE TEKMAR CONTROLLER FOR ALL HARDWARE POINTS LISTED FOR SYSTEM OPERATION TO MEET SPECIFICATION OPERATING SEQUENCES.

### FAN COIL UNITS

- THE FAN COIL IS CALLED TO RUN BY THE SPACE THERMOSTAT. UPON A CALL FOR HEAT OR COOLING, THE FAN COIL ZONE VALVE OPENS TO ALLOW TEMPERED WATER TO FLOW THROUGH THE COIL AND THE COIL STARTS TO GENERATE HEATING OR COOLING BASED ON THE CALL. WHEN THE THERMOSTAT IS SATISFIED, THE FAN COIL SHALL SHUT DOWN AND THE ZONE VALVE SHALL CLOSE.
- DIRECT ACTING LINE VOLTAGE ELECTRIC THERMOSTAT ENERGIZES THE ASSOCIATED FAN MOTOR WHEN THE SPACE TEMPERATURE IS BELOW SET POINT

FLOW THROUGH THE HEATING COIL IS CONTINUOUS WHEN HEATING PUMPS ARE OPERATIONAL. THERMOSTAT GUARDS ARE TO BE PROVIDED IN ALL COMMON AREAS SUCH AS LOBBIES, STAIRWELLS AND VESTIBULES.

### PRIMARY FAN COIL WATER TEMPERATURE MONITORING

5.6.1. THE FOLLOWING TEMPERATURES WILL BE MONITORED:

5.6.1.a. PRIMARY HEATING WATER SUPPLY. 5.6.1.b. PRIMARY HEATING WATER RETURN..

# APPROVED ALTERNATES

6 0 7 HYDRONIC FOUIPMENT

ACCEPTANCE.

6.0.1. FAN COILS CARRIER, DAIKIN, TITUS, TRANE, PRICE

6.0.2. DOMESTIC WATER HEATERS A.O. SMITH, BRADFORD WHITE, LOCHINVAR 6.0.3. DIFFUSERS, GRILLES TITUS, E.H. PRICE, NAILOR

6.0.4. HRV'S LENNOX, LIFEBREATH, VANEE

WILO, ARMSTRONG, GRUNDFOS, MYERS 6.0.5. PUMPS 6.0.6. DRAINS ZURN, WATTS, WADE

ENGINEERED AIR, ROSEMEX, SIGMA FOR PLUMBING FIXTURE ALTERNATES, REVIEW WITH OWNER AND CONSULTANT FOR

4711 Yonge St. Suite 800 Toronto, ON M2N 6K8 T.416.497.3662 info@glsmith.ca www.glsmith.ca

G.L. SMITI

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KILDONAN CROSSING 1616 REGENT AVE V WINNIPEG, ME CRU # 4

SPECIFICATIONS

# Date Description

DRAWING TITLE:

PRINT DATE: SCALE: 2023-05-18 AS NOTED DRAWN BY: TW

CHECKED BY: PROJECT NO:





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PRINT DATE:

2023-05-18

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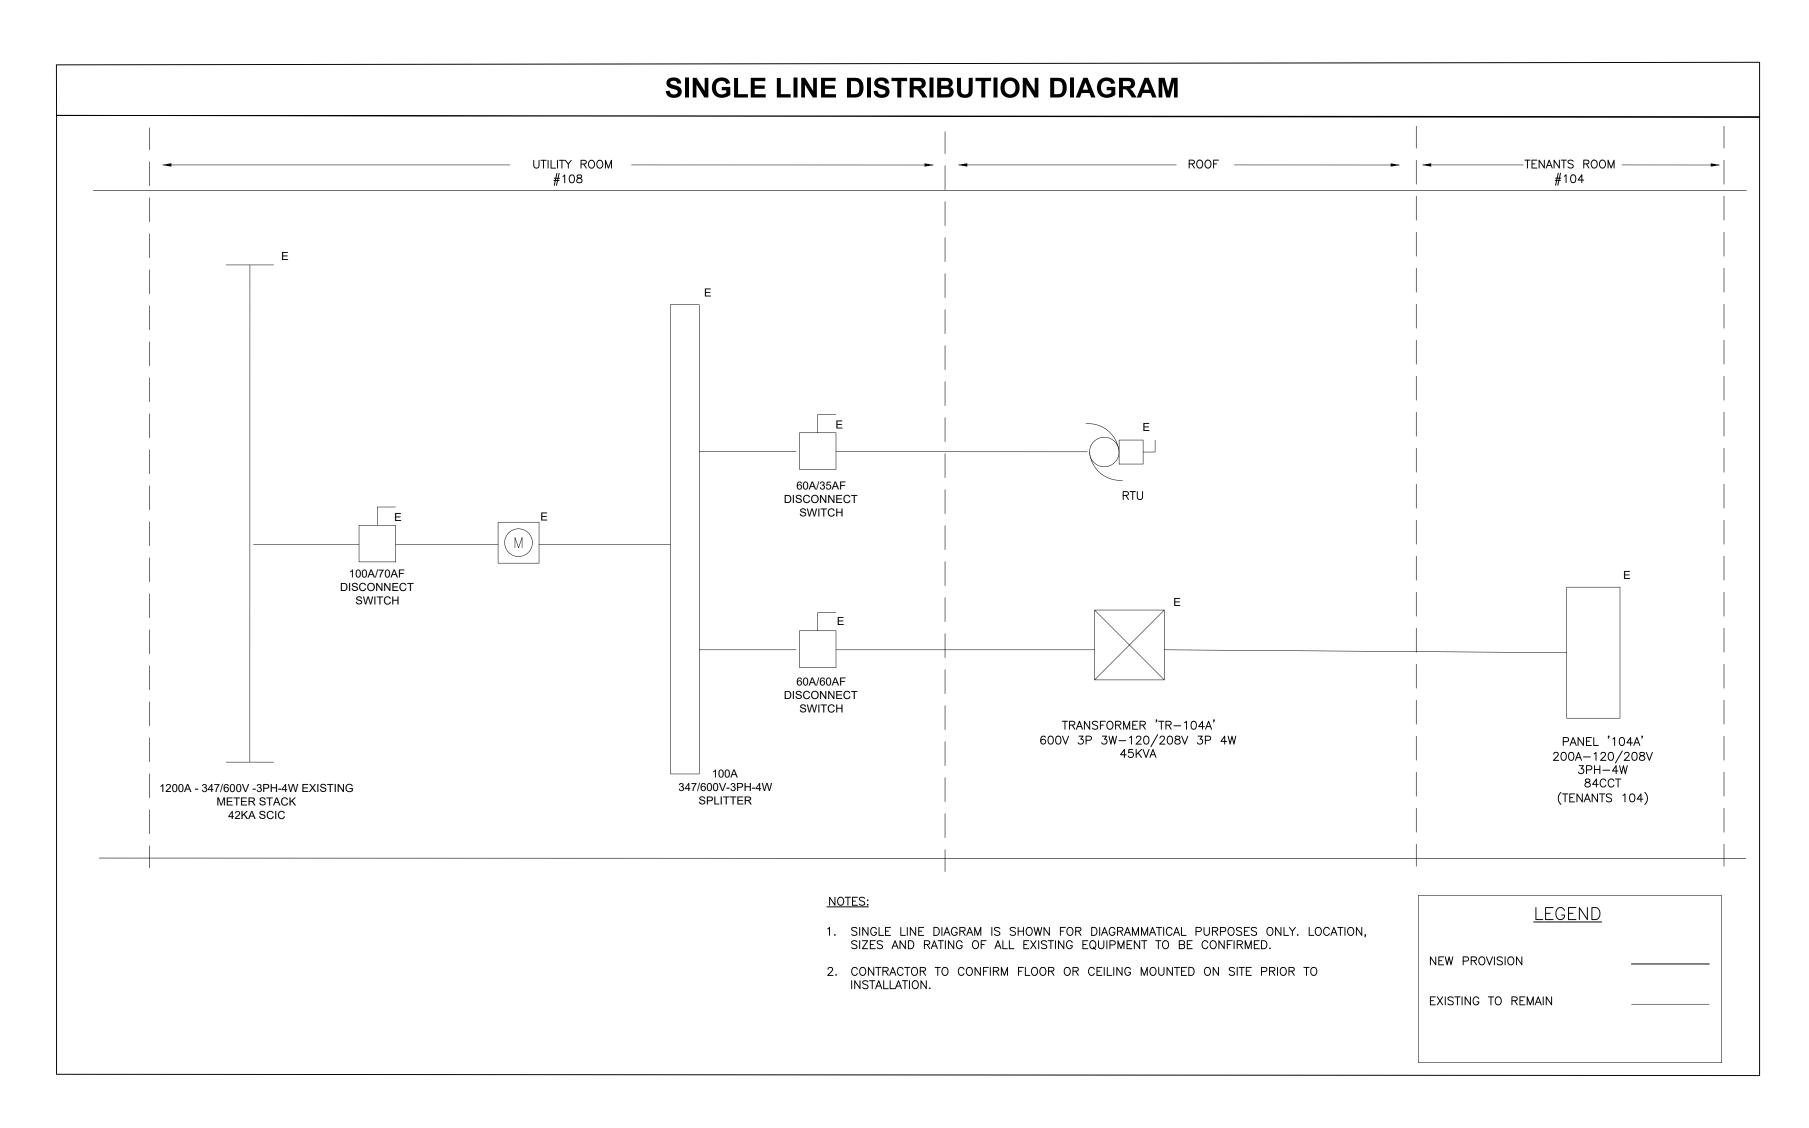
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1 SINGLE LINE DIAGRAM E1.1 SCALE: N.T.S.

		LOA	D CALCULA	TION SUI	MMARY			
DESCRIPTION	INTERIOR LIGHTING(WATTS)	EXTERIOR LIGHTING(WATTS)	SERVICE EQUIPMENT @ 60%(WATTS)	HOT WATER TANK(WATTS)	MISC @ 50%(WATTS)	HEATERS @ 70%(WATTS)	FAN COIL UNITS(WATTS)	TOTAL (208V-3Ø)( WATTS)
CONNECTED LOAD	2110	500	6000	3000	500	8000	100	20210
DIVERSITY FACTOR	100%	100%	60%	100%	50%	70%	100%	
DEMAND LOAD	2110	500	3600	3000	250	5600	100	15160

2 LOAD CALCULATION SUMMARY E1.1 SCALE: N.T.S.

PANEL OPTIONS:				LOA	) A [K	W]:		5			PHA	SE VOLTAGE [V]:	120
2 :CSA ENCLOSURE RATING		FLUSH		LOAL	) B [K	W]:		5.5			LINE	VOLTAGE [V]:	208
FEED THROUGH	X	SURFACE		LOAD	C [K	W]:		4.8			PHA	SE:	34
SUB-FEED	X	BOLT-ON	BREAKER	TOTA	L [KV	V]:		15			WIRE	Ξ:	4
MAIN BREAKER		SPD									MAII	NS [A]:	22
200% RATED NEUTRAL BUS				CUR	RENT	A [A]	]:	42			IIAM	N BREAKER [A]:	20
ISOLATED GROUND BUS				CURI	RENT	B [A]	]:	45			I.C. [	kA]:	10
				CUR	RENT	C [A]	]:	40					
	D.F	CONN.	DEMAND	BKB	CCT	Ф	CCT	BKR	DEMAND	CONN.	D.F		
DESCRIPTION			LOAD [W]		NO.	Ψ	NO.		LOAD [W]			DESCRIPTION	
LIGHTING(EXISITING)	[/0]	LOND [W]	LOAD [W]	15	1	Λ	2	15	500	500	100	EMERGENCY /NL LIGHT	
POWER DOOR OPERATOR	50	500	250	15	3	A B	4	15	255	255	100	PUBLIC LIGHT	
RECEPTACLE(EXISITING)	50	500	250	15	5	С	6	15	500	500	100	EXTERIOR SIGNAGE	
EXTERIOR SIGNAGE	100	500	500	15	7	A	8	15	240	240	100	TATOO RM #1 LIGHT	
EXTERIOR SIGNAGE (EXISTING)	100	300	300	15	9	В	10	15	192	192	100	TATOO RM #2 LIGHT	
GF WP T-SLOT RECEPTACLE(EXISITING)				20	11	С	12	15	192	192	100	TATOO RM #2 LIGHT	
TATOO RM #1 RECP	60	700	420	20	13	Α	14	15	192	192	100	PIERCING RM LIGHT	
TATOO RM #2 RECP	60	700	420	20	15	В	16	15	192	192	100	STORAGE/WASH RM LIGHT	
TATOO RM #3 RECP	60	700	420	20	17	С	18	15	50	50	100	EF-1	
PIERCING RM RECP	60	700	420	20	19	A	20	15	50	50	100	EF-2	
REPROCESSING RM RECP	60	500	300	20	21	В	22	20	1500	1500	100		
SALE AREA RECP	60	500	300	15	23	С	24	2P	1500	1500	100	H.W.T.	
SALE AREA RECP	60	500	300	15	25	A	26	15	700	1000	70		
P.O.S RECP	60	500	300	15	27	В	28	2P	700	1000	70	FFH-1	
CORRIDOR RECP	60	500	300	15	29	С	30	15	700	1000	70		
W/R RECP	60	200	120	15	31	Α	32	2P	700	1000	70	FFH-2	
STORAGE RM RECP	60	500	300	15	33	В	34	15	525	750	70		
SPACE	-	300		10	35	С	36	2P	525	750	70	BBH-1	
SPACE					37	Α	38	15	525	750	70		
SPACE					39	В	40	2P	525	750	70	BBH-2	
SPACE					41	С	42	15	350	500	70		
SPACE					43	Α	44	2P	350	500	70	BBH-3	
SPACE					45	В	46	21	550	300		SPACE	
SPACE					47	С	48					SPACE	
SPACE					49	Α	50					SPACE	
SPACE					51	В	52					SPACE	
SPACE					53	С	54					SPACE	
SPACE					55	Α	56					SPACE	
SPACE					57	В	58					SPACE	
SPACE					59	С	60					SPACE	
SPACE					61	Α	62					SPACE	
SPACE					63	В	64					SPACE	
SPACE					65	С	66					SPACE	
SPACE					67	Α	68					SPACE	
SPACE					69	В	70					SPACE	
SPACE					71	С	72					SPACE	
SPACE					73	Α	74					SPACE	
SPACE					75	В	76					SPACE	
SPACE					77	С	78					SPACE	
SPACE					79	Α	80					SPACE	
SPACE					81	В	82					SPACE	
SPACE					83	С	84					SPACE	
<b>NOTES:</b> 1. Panel Enclosure To Be Sprinklerproof. 2. Panels greater than 84 circuits to be double tub	).												
PANEL: '104A'			PROJECT N	IAME:	23-10	20							
(EXISTING)			LOCATION R2C 5C6 C FED FROM	RU #4				/ WINI	NIPEG,MB				G.



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	4	2023-05-18	ISSUED FOR TENDER	SW
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	3	2023-05-17	ISSUED FOR PERMIT	SW

2 2023-05-04 ISSUED FOR LLORD REVIEW ISSUED FOR CLIENT REVIEW # Date Description

PROJECT TITLE:

ISSUE



KILDONAN CROSSING 1616 REGENT AVE W WINNIPEG, MB R2C 5C6 CRU # 4


REVISION			

SINGLE LINE DIAGRAM AND
RISER PANEL SCHEDULES

# Date Description

DRAWING TITLE:

PRINT DATE:	SCALE:
2023-05-18	AS NOTED
DRAWN BY:	DRAWING NO:
BA	
CHECKED BY:	
ZH	$\vdash$ $\vdash$ $\vdash$
PROJECT NO:	

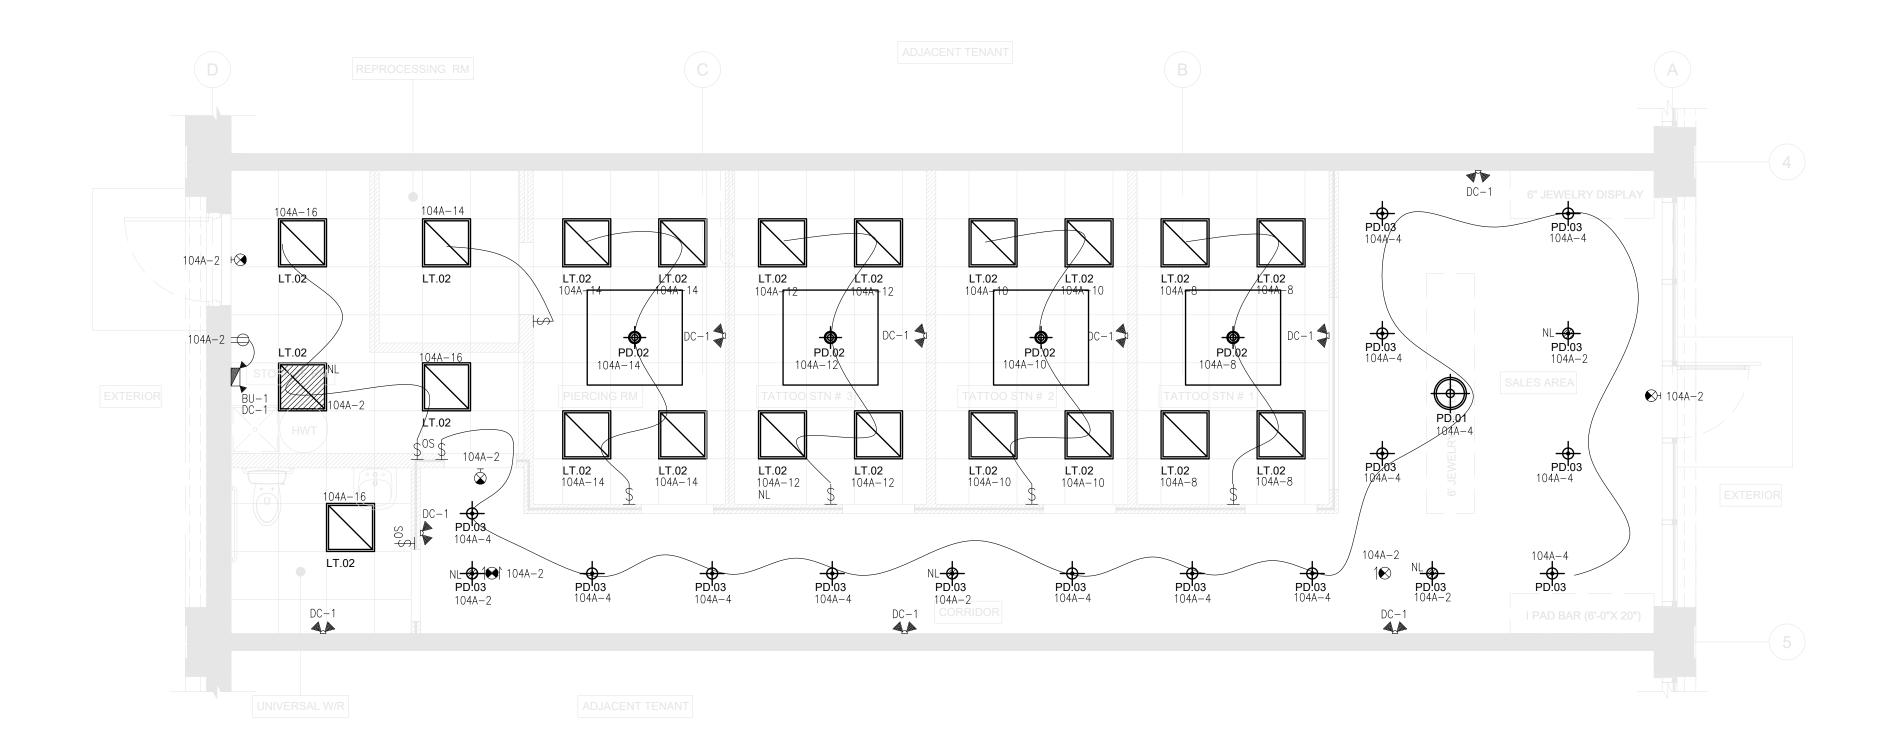



### **GENERAL NOTES**

- 1. LAMPS TO BE AS SPECIFIED ON LUMINAIRE SCHEDULE NO EXCEPTIONS OR ALTERNATES WITHOUT APPROVAL BY CONSTRUCTION PROJECT MANAGER.
- 2. THE ELECTRICAL CONTRACTOR IS TO MEASURE THE ILLUMINATION OF THE FLOOR AT NIGHT WITH EMERGENCY LIGHTING ON ONLY, AND SEND A DRAWING SHOWING THE MAXIMUM AND MINIMUM LEVEL OF ILLUMINATION, TO THE CONSULTING ENGINEER, FOR REVIEW. PROVIDE WRITTEN CONFIRMATION THAT EMERGENCY LIGHTING HAS BEEN INSTALLED IN ACCORDANCE WITH CONTRACT DOCUMENTS AND LATEST EDITION OF THE ONTARIO BUILDING CODE SECTIONS 3.2.7.3 AND 3.2.7.4. LETTER TO BE INCLUDED AS PART OF CLOSE-OUT DOCUMENTS SUBMITTAL PACKAGE. INCLUDE FOR SUPPLY AND INSTALL OF AN ADDITIONAL 2 EXIT SIGNS FOLLOWING BUILDING INSPECTOR WALKTH-ROUGH.
- 3. THE ELECTRICAL CONTRACTOR IS TO ENSURE THAT ALL LIGHTING FIXTURES ARE CLEAN AND ILLUMINATED BY END OF PROJECT.
- 4. LIGHTING FIXTURES IDENTIFIED AS NIGHT LIGHT ARE TO REMAIN ON AT ALL TIMES.
- 5. ALL EXISTING LIGHTS MUST BE RELAMPED IN LED.
- 6. FINAL CONNECTION OF BX(AC-90) ARMORED CABLE FROM A CEILING OUTLET BOX TO A LIGHTING FIXTURE SHALL NOT EXCEED 3 METERS.
- 7. GC TO ENSURE ALL ELECTRICAL CABLING INSIDE FIXTURES AND MILLWORK ARE CONCEALED AND INTEGRATED FOR A CLEAN OVERALL APPEARANCE.

# O DRAWING NOTES

- CONTRACTOR TO PROVIDE A LOCKALBE TYPE BREAKER FOR EMERGENCY AND NIGHT LIGHT CCTS.
- ENSURE THAT SECURITY CAMERAS AND FIRE ALARMS ARE EMBEDDED IN THE CEILING OR ARE INSTALLED IN DISCRETE AREAS.
- 3. SPEAKERS ARE TO BE FLUSH RECESSED, TO MATCH ADJACENT CEILING/WALL AND TO BE A MIN 10' 0" FROM ENTRANCE.
- 4. NEW FIRE ALARM SPEAKER/STROBES ARE TO BE NEW 8" TYPE. ALL WORK ASSOCIATED WITH THE FIRE ALARM SYSTEM IS TO BE COMPLETED BY THE BASE BUILDING FIRE ALARM CONTRACTOR AT THE TENANT'S EXPENSE.

	EMERGENCY LIGHTING SCHEDULE							
TAGS	MANUFACTURER/CAT.#	DESCRIPTION	VOLT	WATTS	REMARK			
BATTERY UNIT	STAN-SLC12200-2N3WLJ-2H	DOUBLE HEAD EMERGENCY LIGHT WITH BATTERY PACK	12V	200W				
EXIT SIGN	STAN-RMS-0-WH-UDC	ILLUMINATED EXIT SIGN SINGLE FACE EXIT	120V	2W	SLIM LED			
REMOTE HEADS	STAN-N2-06-12V4WLJ	STANPRO DOUBLE HEAD EMERGENCY LIGHT	12V	4W				

ENSURE MINIMUM 30MIN RUNTIME FOR ALL EMERGENCY LIGHTING

	TYPE	DESCRIPTION	WATTS	LAMPS	REMARK
LT.02	LT.02	2' x 2' LED EDGE LIT FIXTURE. CAT#: FEIT ELECTRIC FP2X2/4WY/WH	48W	LED, 4,000K	
O PD.01	PD.01	DECORATIVE PENDANT. CONFIRM FINISH WITH ARCHITECT BEFORE PLACING ORDER. CONFIRM WITH ARCHITECT EXACT QUANTITIES.  CAT#: MODERN FORMS LIGHTING PD-24848-BK	107W	LED, 3,000K	SUSPENDED AT 7' AFF
PD.02	PD.02	DECORATIVE PENDANT. CONFIRM FINISH WITH ARCHITECT BEFORE PLACING ORDER. CONFIRM WITH ARCHITECT EXACT QUANTITIES. CAT#: KUZCO LIGHTING PD85548-BK	60W	LED, 3,000K	SUSPENDED AT 7' AFF
PD!03	PD.03	DECORATIVE PENDANT. CONFIRM FINISH WITH ARCHITECT BEFORE PLACING ORDER. CONFIRM WITH ARCHITECT EXACT QUANTITIES. CAT#: LIGHTOLIER 3DP-CY-BKST-LC-S-DI-BK-BK-E26-PAR38	15W	LED, 3,000K	SUSPENDED AT 9' AFF



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4	2023-05-18	ISSUED FOR TENDER	SW
3	2023-05-17	ISSUED FOR PERMIT	SW
2	2023-05-04	ISSUED FOR LLORD REVIEW	SW

# Date
PROJECT TITL

STEEL

Description

Dwn

KILDONAN CROSSING 1616 REGENT AVE W WINNIPEG, MB R2C 5C6 CRU # 4

REVI	SION		
#	Date	Description	

LIGHTING PLAN

PRINT DATE: SCALE:
2023-05-18 AS NOTED

DRAWN BY:

BA

CHECKED BY:


DRAWING TITLE:

CHECKED BY:

ZH

PROJECT NO:
23-1020

DRAWING NO:

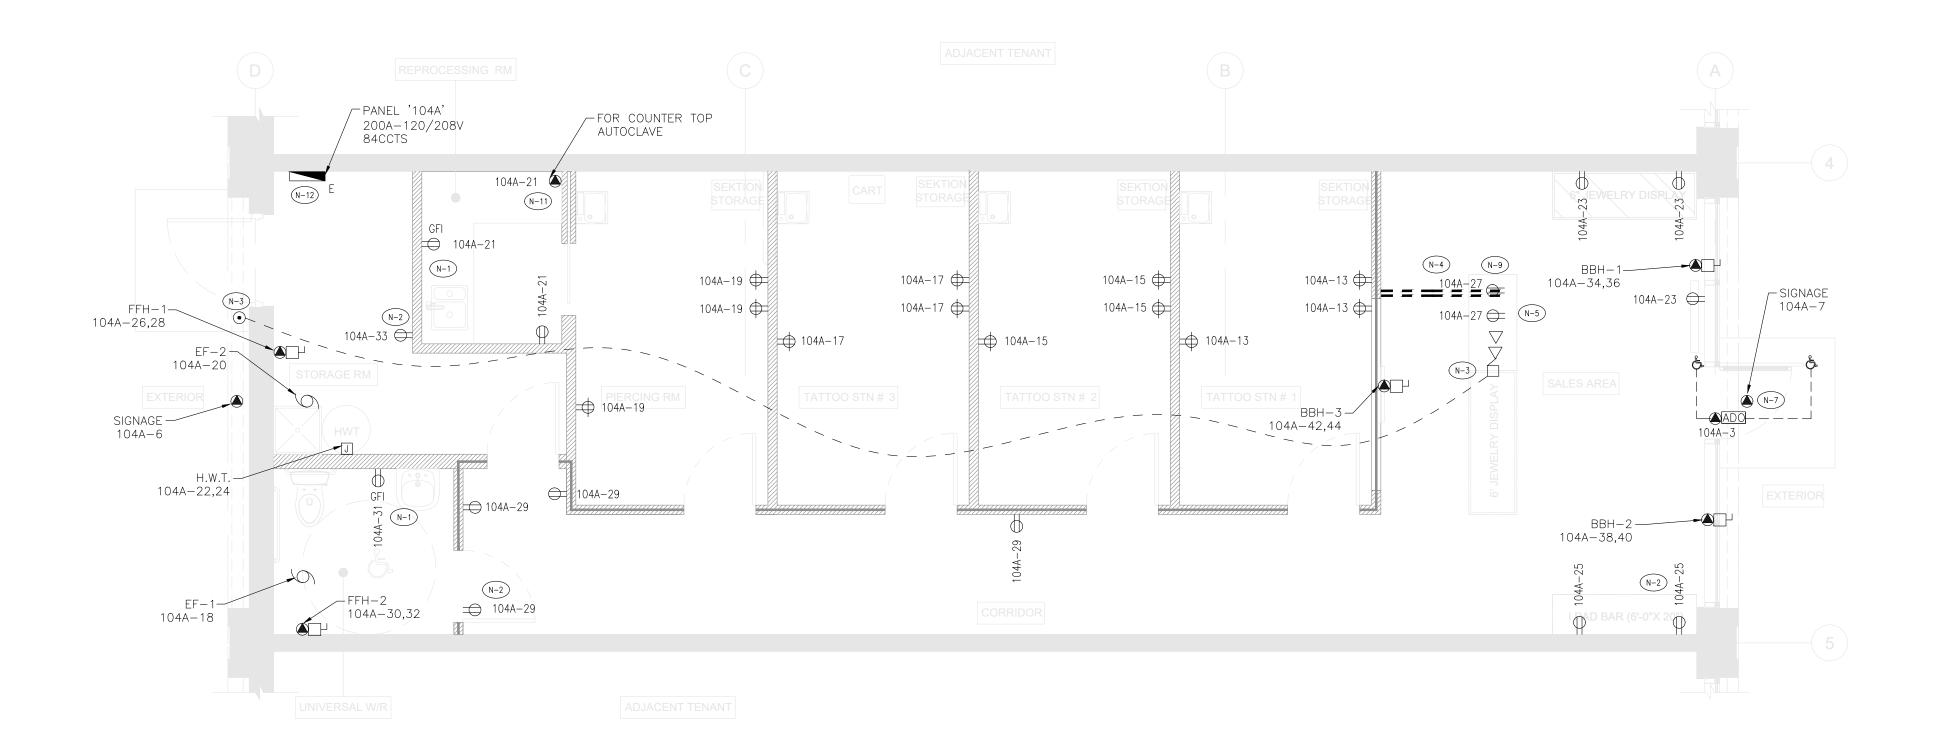

1 POWER & SYSTEMS PLAN E3.0 SCALE: 1/4"=1'-0"

# **GENERAL NOTES**

- 1. THESE DRAWINGS SHALL BE READ IN CONJUNCTION WITH THE INTERIOR/ARCHITECT'S DRAWINGS FOR DIMENSIONS, HEIGHTS, CONSTRUCTION DETAILING, FINISHES AND
- 2. CIRCUITING SHOWN ARE FOR REFERENCE PURPOSES ONLY.
- 3. VERIFY THE EXACT POWER REQUIREMENTS AND RECEPTACLE TYPES FOR SPECIAL EQUIPMENT WITH MANUFACTURER PRIOR TO INSTALLATION.
- 4. CONTRACTOR SHALL VERIFY ALL EQUIPMENT CONNECTIONS PRIOR TO CLOSEOUTS.
- 5. THE ELECTRICAL CONTRACTOR IS TO MARK UP OUTLET AND DEVICE LOCATIONS AND OBTAIN APPROVAL BY THE DESIGN CONSULTANT, PRIOR TO INSTALLATION.
- 6. THE ELECTRICAL CONTRACTOR SHALL SUPPLY AND INSTALL SUITABLE LABELS ON ALL RECEPTACLES AND SYSTEM FURNITURE FEEDS. LABEL TO INCLUDE BOTH THE PANEL AND CIRCUIT DESIGNATION. REVIEW LABEL SIZE AND TYPE WITH CONSULTANT PRIOR TO
- 7. ALARM CABLING BY OTHERS. ALL OTHER CABLING UNLESS NOTED OTHERWISE TO BE BY
- 8. NEW POWER/VOICE/DATA RECEPTACLES ARE TO BE MOUNTED AT 16" AFF. TO THE CENTERLINE OF THE DEVICE UNLESS OTHERWISE NOTED. ALL SWITCHES ARE TO BE MOUNTED SO THAT THE CENTER LINE OF THE DEVICE ALIGNS WITH THE CENTERLINE OF THE DOOR HARDWARE. ALL CONDUIT AND WIRING IS TO BE CONCEALED WITHIN WALLS, ALSO COORDINATE WITH MILLWORK.
- 9. ALL CAT 6 CABLES TO BE TERMINATED\*KEYSTONE PLATED) AND LABELED BY T.G.C.



1. GFI RECEPTACLE MOUNTED 42" A.F.F

2. RECEPTACLE MOUNTED 9FT A.F.F.

- 3. ELECTRICAL CONTRACTOR SHALL PROVIDE AND INSTALL DOOR BUZZER SYSTEM COMPLETE WITH BUZZER AS SHOWN.
- 4. G.C TO TRENCH AS NOTED C/W TWO(2) SEPARATE 3/4" DIAMETER CONDUITS, ONE FOR POWER AND ONE FOR COMMUNICATION. ALL SUPPLIED, INSTALLED & TERMINATED BY G.C.REFER DETAIL TO 1/E4.0.
- 5. NEW POWER/VOCIE/DATA RECEPTACLES ARE TO BE MOUNTED AT 16" AFF. TO THE CENTERLINE OF THE DEVICE UNLESS OTHERWISE NOTED. ALL SWITCHES ARE TO BE MOUNTED SO THAT THE CENTER LINE OF THE DEVICE ALIGNS WITH THE CENTERLINE OF THE DOOR HARDWARE. ALL CONDUIT AND WIRING IS TO BE CONCEALED WITHIN WALLS, ALSO COORDINATE WITH MILLWORK.
- 7. POWER FOR TENANT SUPPLIED SIGN. POWER TO BE ON A TIME CLOCK.
- 8. CONTRACTOR TO SUPPLY AND INSTALL EMPTY CONDUIT, C/W PULL STRINGS, WIRING, CONNECTIONS AND BOXES FOR ALL SECURITY AND CABLE TELEVISION WIRING.
- 9. ALL CABLING TO BE CAT6.
- 10. ALARM CABLING BY OTHERS. ALL OTHER CABLING UNLESS NOTED OTHERWISE TO BE BY
- 11. DIRECT CONNECTION MOUNTED 42" A.F.F
- 12. CONTRACTOR SHALL CONFIRM WITH LANDLORD OF EXISTING DISTRIBUTION IN CRU #4



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# Date Description

PROJECT TITLE:

STEEL INK

KILDONAN CROSSING 1616 REGENT AVE W WINNIPEG, MB R2C 5C6 CRU # 4

# Date Description

DRAWING TITLE:


POWER & SYSTEMS & RISER PANEL SCHEDULE


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PRINT DATE: 2023-05-18 DRAWING NO: DRAWN BY: BA CHECKED BY:

23-1020

AS NOTED PROJECT NO:



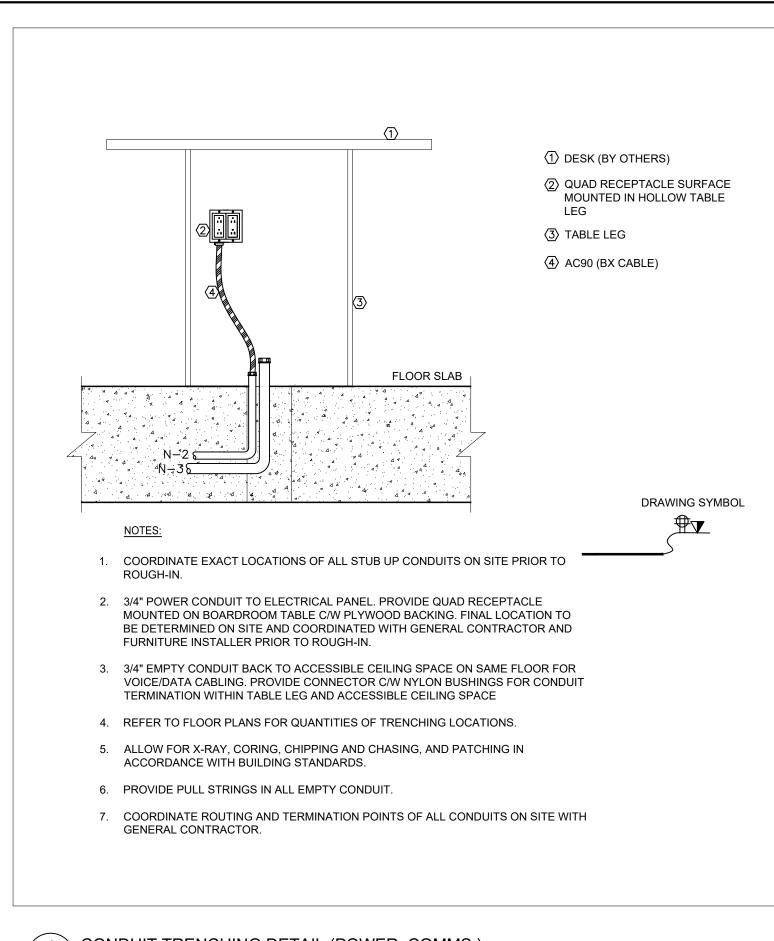

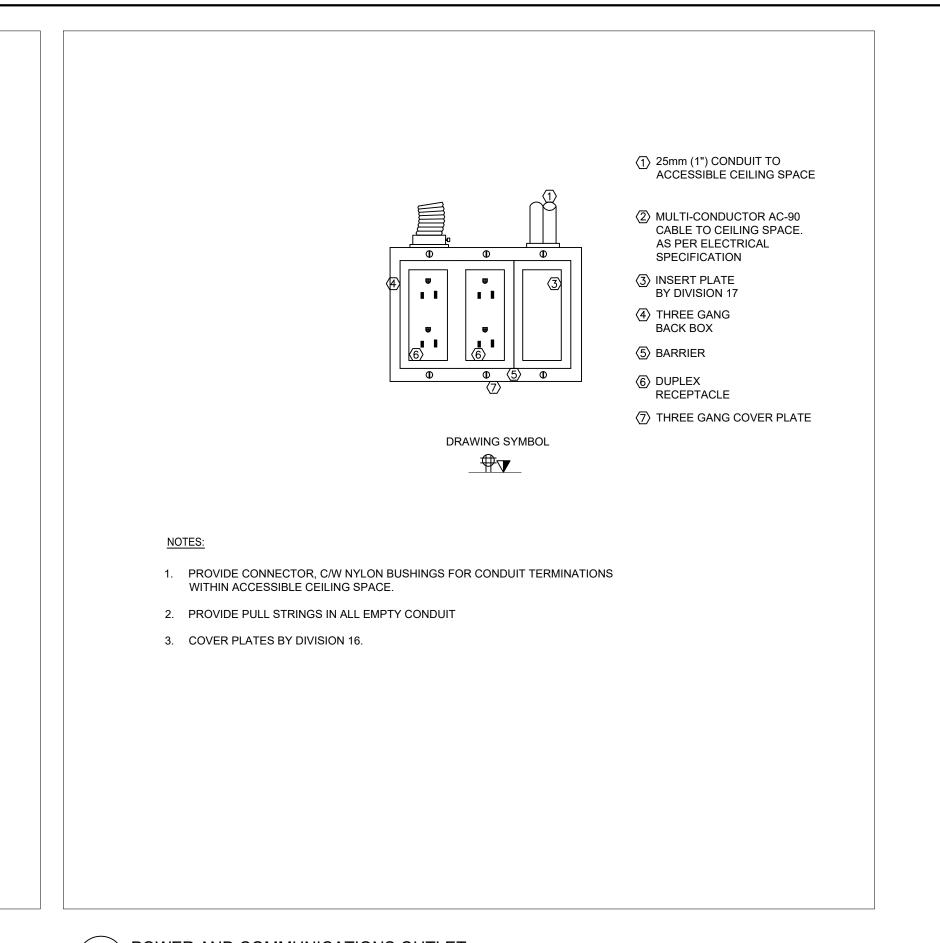1 CONDUIT TRENCHING DETAIL (POWER, COMMS.) E4.0 SCALE: N.T.S.

POWER AND COMMUNICATIONS OUTLET E4.0 SCALE: N.T.S.



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4 2023-05-18 ISSUED FOR TENDER 3 2023-05-17 ISSUED FOR PERMIT 2 2023-05-04 ISSUED FOR LLORD REVIEW 1 2023-04-25 ISSUED FOR CLIENT REVIEW

# Date Description PROJECT TITLE:

REVISION

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KILDONAN CROSSING 1616 REGENT AVE W WINNIPEG, MB R2C 5C6 CRU # 4

# Date Description DRAWING TITLE:

> ELECTRICAL DETAILS & SINGLE LINE DIAGRAM

2023-05-18 BA

CHECKED BY: PROJECT NO:

23-1020

DRAWING NO:

AS NOTED

# **ELECTRICAL SPECIFICATIONS**

#### PART 1 - GENERAL

- 1.1 THE GENERAL CONDITIONS AND INSTRUCTIONS TO BIDDERS AS SET FORTH IN THE GENERAL CONTRACT SPECIFICATIONS AND ALL ADDENDA THERETO SHALL APPLY TO,
- AND GOVERN ALL PORTIONS OF THE ELECTRICAL WORK 1.2 POINTS NOT SPECIFICALLY MENTIONED SHALL BE IN STRICT ACCORDANCE WITH THE CURRENT VERSION OF THE CANADIAN ELECTRICAL CODE AND REGULATIONS OF THE
- ELECTRICAL INSPECTION DEPARTMENT FROM WHICH THE PERMIT WAS OBTAINED 1.3 WHERE THE TERMS "FURNISH". "PROVIDE" OR "INSTALL" APPEAR IN THIS DIVISION. OR A MANUFACTURER IS INDICATED WITH ITEM OR PRODUCT CATALOG NUMBER LISTED, IT IS THE CONTRACTOR'S RESPONSIBILITY TO FURNISH AND INSTALL THE ITEM COMPLETE AND OPERATING FOR THE PURPOSE OR FUNCTION INTENDED, UNLESS OTHERWISE NOTED
- 1.4 WHERE THE TERM "WORK" APPEARS IN THIS DIVISION, IT INCLUDES ALL LABOUR, MATERIALS AND SERVICES REQUIRED AS DESCRIBED IN THE CONTRACT DOCUMENT.
- 1.5 IN CASES OF CONFLICT(s) WITH HE DRAWINGS AND SPECIFICATIONS, THE SPECIFICATIONS SHALL GOVERN 1.6 PRIOR TO PROCEEDING WITH THE WORK, THE CONTRACTOR SHALL THOROUGHLY EXAMINE AND VERIFY DRAWINGS, SPECIFICATIONS AND AMENDMENTS FOR ANY ERRORS, INCONSISTENCIES AND DEVIATIONS WHICH MAYBE DISCLOSED BY SUCH EXAMINATIONS. THE CONTRACTOR SHALL NOT PROCEED WITH ANY WORK WHILE

UNCERTAIN TO ANY INTERPRETATION ON THE DRAWINGS OR THE SPECIFICATIONS.

#### PART 2 - CODES, PERMITS AND INSPECTIONS

- 2.1 THE INSTALLATION SHALL COMPLY WITH THE REQUIREMENTS OF THE CURRENT EDITION OF THE CANADIAN ELECTRICAL CODE (AS AMENDED BY THE AUTHORITY HAVING JURISDICTION), LOCAL BUILDING CODE AND THE REGULATIONS OF THE ELECTRICAL INSPECTION DEPARTMENT HAVING JURISDICTION
- 2.2 THE ELECTRICAL TRADE SHALL OBTAIN ALL ELECTRICAL PERMITS REQUIRED AND, AFTER COMPLETION OF THE WORK, SHALL FURNISH TO THE ENGINEER A CERTIFICATE OF FINAL INSPECTION AND APPROVAL FROM THE INSPECTION DEPARTMENT.
- 2.3 FEES FOR ALL PERMITS AND LICENSES REQUIRED FOR THE WORK SHALL BE INCLUDED BY THE ELECTRICAL CONTRACTOR.

#### PART 3 - STANDARD OF ACCEPTANCE

- 3.1 ALL MATERIALS SHALL BE NEW AND OF THE QUALITY SPECIFIED UNLESS SPECIFICALLY SHOWN AS EXISTING TO BE RE-USED IN THE CONTRACT DOCUMENTS. NEW MATERIALS SHALL CONFORM TO THE STANDARDS OF THE CSA AND THE ULC AND APPROVED BY THESE AGENCIES. WHERE APPLICABLE, FOR ANY MATERIAL NOT CSA APPROVED, THE CONTRACTOR SHALL OBTAIN THE APPROVAL OF THE LOCAL INSPECTION AUTHORITY AND SHALL BEAR ALL INSPECTION CHARGES LEVIED AND ANY MODIFICATION COSTS
- 3.2 ALL PHASES OF THE ELECTRICAL INSTALLATION SHALL BE EXECUTED IN A SATISFACTORY WORKMANLIKE MANNER AND SHALL PRESENT A NEAT APPEARANCE WHEN COMPLETED. WORK NOT DEEMED SATISFACTORY TO THE ENGINEER SHALL BE CORRECTED AT THE CONTRACTOR'S EXPENSE.

#### PART 4 - SETTING OUT THE WORK

- 4.1 ELECTRICAL WORK IS TO BE CARRIED OUT BY QUALIFIED, LICENSED ELECTRICIANS WHO HOLD A VALID PROVINCIAL LICENSE IN ACCORDANCE WITH THE ELECTRICAL SAFETY
- AUTHORITY (FSA) 4.2 THE ELECTRICAL CONTRACTOR SHALL BE RESPONSIBLE FOR CORRECTING ALL WORK COMPLETED CONTRARY TO THE INTENT OF THE DRAWINGS AND SPECIFICATIONS AND SHALL BEAR ALL COSTS FOR SAME. WHERE THE INTENT OF THE DRAWINGS AND SPECIFICATIONS ARE NOT CLEAN, THE CONTRACTOR SHALL OBTAIN CLARIFICATION
- FROM THE ENGINEER PRIOR TO PROCEEDING WITH THE WORK 4.3 WHERE ANY EQUIPMENT SUPPLIED BY THE ELECTRICAL TRADE MUST BE BUILT-IN WITH WORK OF OTHER CONTRACTORS, THE ELECTRICAL CONTRACTOR SHALL BE RESPONSIBLE FOR THE SUPPLYING OF THE EQUIPMENT TO BE BUILT-IN OR MEASUREMENTS TO ALLOW NECESSARY OPENINGS TO BE LEFT SO AS NOT TO HOLD UP
- 4.4 THE ELECTRICAL TRADE, IN SETTING OUT OF HIS WORK, SHALL MAKE REFERENCE TO ALL OTHER DISCIPLINES AND SPECIFICATIONS. THE ELECTRICAL CONTRACTOR SHALL CONSULT WITH THE RESPECTIVE TRADES IN SETTING OUT LOCATIONS FOR ALL EQUIPMENT AND WIRING SO THAT CONFLICTS ARE AVOIDED AND SYMMETRICAL SPACING IS MAINTAINED.
- 4.5 BEFORE SUBMITTING TENDER, CAREFULLY EXAMINE THE SITE OF THE PROPOSED WORK SO AS TO ASCERTAIN ALL EXISTING CONDITIONS AFFECTING THE WORK NO EXTRAS WILL BE ALLOWED FOR WORK NECESSITATED BY CONDITIONS ORDINARILY EVIDENT ON THE SITE. REPORT TO THE ENGINEER ANY CONDITIONS THAT MAY AFFECT THE PROPER
- 4.6 WHERE LIGHTING FIXTURES, SPEAKERS, ETC. OCCUR IN ACOUSTIC TILE TYPE CEILING. THE FIXTURE OR SPEAKER LOCATION SHALL BE COORDINATED WITH THE TILE PATTERN AND SHALL BE ADJUSTED, IF REQUIRED TO SUIT THE TILE PATTERN.
- 4.7 WHERE RECEPTACLES ARE MOUNTED ABOVE COUNTERS, BENCHES, BACKSPLASHES, ETC., LOCATION AND MOUNTING HEIGHTS SHALL BE COORDINATED WITH THE BUILT-IN UNITS AND ARCHITECTURAL DRAWINGS.
- 4.8 MOUNTING HEIGHTS SHALL BE COORDINATED WITH ARCHITECTURAL DETAILS AND SHALL BE ADJUSTED, IF REQUIRED, TO SUIT PANELING, DADOS, MASONRY COURSE

### PART 5 - TESTING

5.1 PERFORM MEGGER TESTS ON ALL FEEDERS TO ENSURE THAT THE C.E.C. REQUIREMENTS ARE MET. TAKE CURRENT READINGS ON ALL FEEDERS AND IF LOAD UNBALANCE EXCEEDS 15%, RECONNECT LOADS TO BRING WITHIN BALANCE.

### PART 6 - CO-ORDINATION AND CO-OPERATION

- 6.1 COORDINATE WORK WITH ALL TRADES TO ENSURE A PROPER AND COMPLETE INSTALLATION. NOTIFY ALL TRADES FOR REQUIREMENTS FOR OPENINGS, SLEEVES, INSERTS AND OTHER HARDWARE NECESSARY IN THEIR WORK FOR INSTALLATION OF YOUR WORK, AND, WHERE YOUR WORK TO BE INTEGRATED WITH WORK OF TRADES CAREFULLY COORDINATE ALL WORK PRIOR TO AND DURING INSTALLATION.
- 6.2 COORDINATE AND PLAN EXACT LOCATIONS AND ROUTING OF SERVICES WITH ALL TRADES AFFECTED PRIOR TO INSTALLATION, GENERALLY, PIPING REQUIRING UNIFORM PITCH SHALL BE GIVEN RIGHT OF WAY, WITH OTHER SERVICES LOCATED AND ARRANGED TO SUIT.

### PART 7 - GUARANTEE/WARRANTY

- 7.1 THE ELECTRICAL CONTRACTOR SHALL PROVIDE A WRITTEN GUARANTEE FOR THE 1. ALL WORK EXECUTED UNDER THIS CONTRACT WILL BE FREE FROM DEFECTS OF WORKMANSHIP AND MATERIALS FOR A PERIOD OF ONE (1) YEAR FROM
- THE DATE OF SUBSTANTIAL COMPLETION. 2. CONTRACTOR AGREES THAT IT WILL. AT ITS OWN EXPENSE. REPAIR AND REPLACE ALL SUCH DEFECTIVE WORK AND OTHER WORK DAMAGED
- THEREBY WHICH FAILS OR BECOMES DEFECTIVE DURING THE TERM OF THE WARRANTY PERIOD PROVIDED SUCH FAILURE IS NOT A RESULT OF IMPROPER USAGE. 3. THE PERIOD OF THE GUARANTEE SPECIFIED SHALL IN NO WAY SUPPLANT ANY OTHER GUARANTEE OF A LONGER PERIOD, BUT SHALL BE BINDING ON WORK NOT OTHERWISE COVERED.

### PART 8 - INTERRUPTIONS TO AND SHUT DOWNS OF EXISTING SERVICES AND SYSTEM

- 8.1 DO NOT SHUT DOWN OR DISCONNECT ANY EXISTING SERVICE OR SYSTEM WITHOUT THE OWNER'S APPROVAL. CONTRACTOR TO PREPARE WORK FOR REQUIRED SHUT-DOWN AND INTERRUPTIONS OF EXISTING SERVICES. THE ACTUAL PERFORMANCE OF THE EXISTING SERVICE OR SYSTEM SHUT DOWN SHALL BE PERFORMED BY THE OWNER'S OWN AUTHORIZED PERSONNEL. ALL SHUT DOWNS SHALL BE COORDINATED WITH THE CONSULTANT ENGINEER AND THE OWNER'S REPRESENTATIVE.
- 8.2 CONTRACTOR TO OBTAIN WRITTEN APPROVAL A MINIMUM OF FIVE (5) DAYS IN ADVANCE OF SHUT DOWNS AND INTERRUPTIONS. INCLUDE FOR ASSOCIATED COSTS OF WORK PERFORMED DURING NIGHTS. WEEKENDS OR TIMES OUTSIDE OF NORMAL WORKING HOURS, AS NECESSARY TO MAINTAIN SERVICES IN OPERATION OR WITH MINIMUM INTERRUPTIONS COMPLYING WITH THE OWNER'S REQUIREMENTS. TO AFTER HOURS

### PART 9 - RECORD DRAWINGS (AS-BUILTS)

9.1 WHEN WORK BEGINS AT SITE ON A DAILY BASIS, CONTRACTOR TO CLEARLY AND ACCURATELY MARK ON A BOUND SET OF WHITE PRINTS OF CONTRACT DRAWINGS ALL CHANGES AND/OR DEVIATIONS INCLUDING THOSE MADE BY ADDENDAS, CHANGE ORDERS, AND SITE INSTRUCTIONS.

- 9.2 MAINTAIN A COPY OF THE AS-BUILT WHITE PRINTS AT SITE FOR PERIODIC INSPECTION BY
- THE CONSULTANT ENGINEER THROUGHOUT THE DURATION OF WORK. 9.3 AS-BUILT DRAWINGS ARE TO INCLUDE ROUTING OF ALL FEEDERS, EXCEPT FOR BRANCH CIRCUITS. LOCATION OF ALL JUNCTION BOXES ARE TO BE SHOWN. QUANTITY OF WIRES IN EACH CONDUIT AND CIRCUIT NUMBERS OF WIRES IN EACH CONDUIT
- 9.3 PRIOR TO APPLYING FOR A CERTIFICATE OF SUBSTANTIAL PERFORMANCE OF WORK, CONTRACTOR TO SUBMIT THE FINAL "AS-BUILT" SITE DRAWING WHITE PRINTS FOR REVIEW BY THE ENGINEER. CONTRACTOR TO MAKE REVISIONS IF REQUESTED BY THE CONSULTANT FNGINFFR
- 9.4 FINAL AS-BUILT PRINTS/PLOTS SHALL NOT CONTAIN MARKINGS OR CORRECTIONS BY HAND (i.e. PEN, PENCIL, MARKERS, AND ETC). REFERENCES TO THE ARCHITECT/INTERIOR DESIGNER AND ENGINEER SHALL BE DELETED FROM THE DRAWINGS/PLANS. FINAL AS-BUILT DRAWINGS SHALL BE IN CAD FORMAT

#### PART 10 - IDENTIFICATION

- 10.1 LABEL ALL PANELS, STARTERS, DISTRIBUTION CENTRES, LIGHTING CONTROLS, TRANSFORMERS WITH 13MM LAMICOID PLATES, PERMANENTLY ATTACHED TO
- 10.2 PROVIDE ADHESIVE LABELS FOR RECEPTACLE CIRCUIT NUMBERS AND VOICE/DATA JACK IDENTIFICATION.

#### PART 11 - HAZARDOUS MATERIAL

- 11.1 IF AT ANY TIME DURING THE COURSE OF WORK ASBESTOS MATERIALS ARE ENCOUNTERED OR SUSPECTED, CONTRACTOR TO CEASE WORK IN AREAS IN QUESTION AND IMMEDIATELY REPORT IN ACCORDANCE WITH ONTARIO REGULATION 654/85 (SECTION 85) TO THE CONSULTANT. DO NOT RESUME WORK IN AFFECTED AREA WITH APPROVAL FROM THE CONSULTANT
- 11.2 MATERIALS CONTAINING MERCURY SHALL BE PROPERLY DISPOSED FROM SITE IN ACCORDANCE WITH LOCAL GOVERNING AUTHORITY REGULATIONS.
- 11.3 CONTRACTOR TO RETAIN THE SERVICES OF SPECIALITY FIRMS LICENSED BY THE LOCAL ALITHORITIES TO HANDLE SLICH HAZARDOLIS MATERIALS AND TO ENSURE PROPER DISPOSAL TO A MINISTRY APPROVED SITE. CONTAIN AND SUBMIT COPIES OF PERMITS AND/OR APPROVALS.

#### PART 12 - CLEAN-UP

12.1 DURING THE COURSE OF THE CONSTRUCTION. CONTRACTOR SHALL KEEP THE SITE REASONABLY CLEAR OF RUBBISH AND WASTE MATERIALS, ON DAILY BASIS. UPON COMPLETION OF WORK REMOVE RUBBISH AND DEBRIS ARRANGE AND PAY FOR REPAIR OF DAMAGES CAUSED AND LEAVE PREMISES AND WORK IN GOOD ORDER.

#### PART 13 - INSPECTION OF WORK

- 13.1 CONSULTANTS SHALL HAVE ACCESS TO WORK SITE AT ALL TIMES, AND SHALL BE NOTIFIED AR AGREED UPON TIMES OF STAGES OF WORK.
- 13.2 WHERE STANDARDS OF WORK ARE SPECIFIED OR IMPLIED AND WORK DOES NOT COMPLY WITH THE PERFORMANCE SPECIFIED OR IMPLIED. SUCH DEFICIENCIES SHALL BE CORRECTED AS DIRECTED BY THE CONSULTANT. ANY CHARGES FOR OWNER'S STAFF, CONSULTANT OR OTHER PERSONNEL(S) RELATED TO SUCH RETESTING SHALL ALSO BE AT THE EXPENSE OF THE CONTRACTOR.

#### PART 14 - NOISE CONTROL

14.1 WORK WHICH MAY CAUSE NOSE DISTURBANCES MUST BE SCHEDULED AT TIMES APPROVED BY THE CONSULTANT. COORDINATE WORK WITH TRADES TO MINIMIZE NOSE

#### PART 15 - CUTTING, PATCHING AND CORE DRILLING

- 15.1 CUT, PATCH AND CORE DRILL OF EXISTING BUILDING REQUIRED FOR INSTALLATION. CUT ALL OPENINGS NO LARGER THAN IS REQUIRED FOR THE SERVICE. CORE DRILL FOR
- INDIVIDUAL SERVICES 15.2 PERFORM CUTTING IN NEAT FASHION WITH PROPER TOOLS AND EQUIPMENT TO OWNER'S
- 15.3 OBTAIN APPROVAL FROM THE STRUCTURAL CONSULTANT PRIOR TO CUTTING OR CORE DRILLING OF ANY OPENINGS OR HOLES. 15.4 IN FIRE RATED CONSTRUCTION, PACK AND SEAL VOIDS BETWEEN OPENINGS AND CONDUITS FOR LENGTH OF OPENING WITH ASBESTOS FREE ELASTOMERIC AND
- INTUMESCENT ULC LISTED MATERIALS. 15.5 INSTALL FIRESTOP AND SMOKE SEAL MATERIALS IN ACCORDANCE WITH ULC AND/OR THE
- GOVERNING BUILDING CODE REQUIREMENTS. 15.5 DO NOT CUT OR DRILL EXISTING WORK WITHOUT OWNER'S APPROVAL. IN EXISTING AREAS ALL CUTTING, AND CORE DRILLING FOR INDIVIDUAL SERVICES IS PART OF THIS DIVISION
- 15.6 UPON COMPLETION OF ALL SERVICES, PATCH ALL OPENINGS TO MATCH THE EXISTING FINISHES.
- 15.7 ANY DAMAGES CAUSED TO THE EXISTING BUILDING AND SERVICES BY CUTTING AND/OR CORE DRILLING SHALL BE THE CONTRACTOR'S RESPONSIBILITY.
- 15.8 ALL ASSOCIATED COST OF CUTTING AND PATCHING IS INCLUDED IN THIS DIVISION.

### PART 16 - WIRING METHODS

- 16.1 ALL WIRING TO BE COPPER, UNLESS OTHERWISE NOTED.
- 16.2 ALL CABLING SHALL BE FT4 RATED EXCEPT IN PLENUM SPACES WHICH SHALL BE FT6 RATED. NOTE THAT THE T-BAR CEILING SPACES FOR THIS PROJECT ARE PLENUM SPACES SO ALL WIRING WITHIN THAT SPACE SHALL BE FT6.
- 16.3 FEEDERS SHALL BE SIZED WITH A MAXIMUM OF 2% VOLTAGE DROP. 16.4 BRANCH CIRCUIT WIRING SHALL BE MINIMUM #12 AWG 90C RATED IN EMT OR AC-90 MAY BE USED, WHERE PERMITTED BY CODE. WHERE WIRE SIZES ARE NOT SHOWN, THE AMPACITY
- MUST MATCH OR EXCEED THAT OF THE PROTECTIVE DEVICE 16.5 WIRING SHALL BE INSTALLED CONTINUOUSLY WITHIN RACEWAYS. SPLICING SHALL ONLY BE PERMITTED AT OUTLETS AND JUNCTION BOXES. 16.6 PROVIDE A BONDING WIRE IN ALL RACEWAYS.
- 16.7 ALL WIRING TO BE CONCEALED IN WALLS, CEILINGS OR FLOORS, WHERE POSSIBLE. EXPOSED CONDUIT OR WIRING SHALL BE RUN PARALLEL TO OR AT RIGHT ANGLES TO THE
- BUILDING LINES. 16.8 PULL BOXES SHALL BE INSTALLED TO BE AS HIDDEN AS POSSIBLE WITHOUT IMPEDING ACCESS.

# PART 17 - WIRING DEVICES

17.1 LIGHT SWITCHES SHALL BE COMMERCIAL GRADE, DECORA STYLE, 15 OR 20A AS REQUIRED,

DEVICES. PROVIDE STAMPED METAL COVER PLATES IN UNFINISHED AREAS AND

WHITE FINISH, UNLESS OTHERWISE NOTED 17.2 RECEPTACLES SHALL BE COMMERCIAL GRADE, DECORA STYLE, 15 OR 20A AS REQUIRED, WHITE FINISH, UNLESS OTHERWISE NOTED. 17.3 COVER PLATES SHALL BE THERMOPLASTIC IN FINISHED AREAS WITH COLOUR TO MATCH

# PART 18 - MOUNTING HEIGHTS

- 18.1 MOUNTING HEIGHTS SHALL BE FROM THE FINISHED FLOOR TO THE CENTRE OF EQUIPMENT, UNLESS OTHERWISE NOTED. IF MOUNTING HEIGHT IS NOT SPECIFIED, VERIFY WITH ENGINEER PRIOR TO INSTALLATION.
  - 1 SWITCHES: 1200MM (48 IN ) 2. RECEPTACLES: 305MM (12 IN.)
  - 3. TELEPHONE/DATA/TELEVISION OUTLETS: 450MM (18 IN.) 4. COUNTER-TOP OUTLETS: 1120MM (44 IN.)

WEATHERPROOF 'IN-USE' COVERS FOR EXTERIOR RECEPTACLES.

### PART 19 - GENERAL CONDUIT AND CONDUCTOR INSTALLATION REQUIREMENTS

- 19.1 INSTALL CONDUIT AND CONDUCTORS CONCEALED TO DEGREE MADE POSSIBLE BY FINISHES AND PROVIDE INSTALLATIONS IN ACCORDANCE WITH THE LOCAL ELECTRICAL SAFETY CODE (I.E. OESC) AND THE LOCAL GOVERNING STANDARDS.
- 19.2 COORDINATE LOCATIONS AND ROUTING OF SERVICES WITH TRADES PRIOR TO INSTALLATION
- 19.3 WHERE CONDUITS AND/OR CONDUCTORS ARE EXPOSED, CONTRACTOR TO PREPARE DETAIL DRAWINGS AND SUBMIT TO CONSULTANT/ENGINEER FOR REVIEW PRIOR TO START OF WORK IN THE AFFECTED AREA. 19.4 WHERE HORIZONTAL CONDUITS AND/OR CONDUCTORS ARE EXPOSED, INSTALL AS HIGH AS
- POSSIBLE, DO NOT INSTALL CONDUITS AND/OR CONDUCTORS WITHIN 6" (150mm) OF HOT PIPES OR EQUIPMENT, UNLESS THEY ARE ASSOCIATED WITH THE EQUIPMENT. 19.5 CONDUITS AND/OR CONDUCTORS SHALL BE SUPPORT FROM THE CEILING/WALL STRUCTURE, DO NOT SUPPORT FROM CEILING HANGERS, DUCTWORK, PIPING, CABLE

- 19.6 AT NO EXTRA COST, ALLOW FOR FINAL RELOCATIONS OF DEVICES UP TO 10' (3M) TO SUIT
- FINAL LOCATIONS PRIOR TO INSTALLATION OF WALL COVERINGS 19.7 GENERALLY, CONDUITS AND/OR CONDUCTORS ARE SIZED IN ELECTRICAL DRAWINGS. IN CASE OF THE TYPE AND SIZING BEING ABSENT IN DRAWINGS. SIZE CONDUITS AND/OR CONDUCTORS REQUIRED FOR THE INTENDED APPLICATION IN ACCORDANCE WITH THE APPLICABLE LOCAL ELECTRICAL SAFETY CODE (I.E. OESC) OR THE LOCAL GOVERNING AUTHORITY REQUIREMENTS.
- 19.8 CONDUCTORS IN PLENUM SPACES AND/OR IN RAISED FLOOR AREAS SHALL COMPLY WITH THE LOCAL BUILDING CODE (I.E. OBC) AND THE LOCAL ELECTRICAL SAFETY CODE (I.E.
- 19.9 IDENTIFY CONDUIT RUNS (I.E. TAG BOTH ENDS OF CONDUIT RUNS). 19.10 BX#12 MAYBE USED IN CEILING SPACE FROM CEILING DISTRIBUTION BOX DOWN TO RECEPTACLES(DIRECT CONNECTION) IN PARTITIONS. BX RUNS IN CEILING NOT TO EXCEED 6096MM(20'-0") IN LENGTH. DO NOT RUN BX CABLES INTO PANELBOARDS.

#### PART 20 - CONDUITS

- 20.1 INTERIOR CONDUITS SHALL BE GALVANIZED, ELECTRICAL METALLIC TUBING (EMT) IN ACCORDANCE WITH CSA C22.2 NO.83, COMPLETE WITH FACTORY MADE BENDS FOR CASES WHERE SITE BENDING IS NOT POSSIBLE, JOINTS AND TERMINATIONS MADE WITH
- SET SCREW TYPE CONNECTORS 20.2 FOR SHORT BRANCH CIRCUIT CONNECTORS TO MOTORIZED EQUIPMENT AND/OR TRANSFORMERS (MINIMUM LENGTH OF 18" (450mm), MAXIMUM LENGTH OF 24" (600mm) WITH 180 DEGREE LOOP WHERE POSSIBLE) PROVIDE GALVANIZED STEEL FLEXIBLE FI UID TIGHT METALLIC CONDUIT IN ACCORDANCE WITH CSA C22 2 NO. 56. COMPLETE WITH IDEAL "STEEL TOUGH" LIQUID TIGHT FLEXIBLE CONDUIT CONNECTORS AND
- 20.3 FOR EXPOSED EXTERIOR CONDUITS, AND FOR INTERIOR CONDUITS GREATER THAN 2" (50mm) IN DIAMETER AND FOR SURFACE MOUNTED CONDUIT AT HEIGHT LESS THAN 4 (1200mm), PROVIDE RIGID GALVANIZED STEEL IN ACCORDANCE WITH CSA C22.2 NO. 45. COMPLETE WITH FITTINGS, CONNECTORS AND RIGID COUPLINGS.
- COMPLETE WITH ELBOWS, COUPLINGS, AND EXPANSION JOINTS AND ETC. AS REQUIRED. 20.5 SUPPORT AND SECURE CONDUITS AS SPACING IN COMPLIANCE WITH THE LOCAL STANDARDS BY MEANS OF GALVANIZED PIPE STRAPS, RING BOLT TYPE HANGERS, CONDUIT CLIPS OR BY OTHER CSA APPROVED MANUFACTURED DEVICES.

20.4 FOR UNDERGROUND APPLICATIONS, PROVIDE CSA APPROVED, RIGID PVC CONDUIT

- 20.6 CONDUIT FITTINGS SHALL BE CONSTRUCTED OF THE SAME MATERIAL AS THE CONDUIT AND SUITABLE FOR THE APPLICATION 20.7 BEND CONDUITS AT FULL CONDUIT DIAMETER, FREE OF KINKING, FLAKING, OR CRACKING
- 20.8 CONDUITS SHALL BE SUPPORTED INDEPENDENTLY OF THE CEILING GRID WITH THEIR
- OWN SUPPORT SYSTEM 20.9 USE FLEXIBLE METAL CONDUITS FOR CONNECTING MOTORS, VIBRATING EQUIPMENT IN DRY AREAS, AND/OR FOR MOVABLE METAL PARTITIONS.
- 20.10 USE LIQUID TIGHT FLEXIBLE METAL CONDUITS FOR CONNECTING MOTORS VIBRATING EQUIPMENT IN DAMP, WET, OR CORROSIVE AREAS, USE ONLY LIQUID TIGHT FITTINGS FOR SUCH APPLICATIONS. FOR LIQUID TIGHT FLEXIBLE METAL CONDUITS, PROVIDE A JACKET WITH A FT6 RATING IN PLENUM SPACES, OTHERWISE PROVIDE A FT4 RATED JACKET
- 20.11 PROVIDE EMT CONDUITS FROM A RAISED FLOOR BRANCH CIRCUIT PANEL TO JUNCTION BOXES IN THE SUB-FLOOR, AND FROM JUNCTION BOXES TO OUTLET BOXES FOR EQUIPMENT CONNECTIONS IN SUB-FLOORS.
- 20.12 PROVIDE SLEEVES FOR ALL NEW CONDUITS PASSING THROUGH FLOORS, ROOF SLABS, CONCRETE WALLS, BEAMS, AND SLAB TO SLAB PARTITIONS.
- 20.13 PROVIDE AIR-TIGHT SEAL AROUND CABLES AND CONDUITS PASSING THROUGH NON-FIRE RATED PARTITIONS AND/OR FLOORS 21.14 FOR CABLES AND CONDUITS PASSING THROUGH FIRE RATED WALLS AND/OR FLOORS, SEAL THE SPACE BETWEEN CONDUIT/CABLE AND SLEEVES WITH AN APPROVED FIRE
- STOP MATERIAL 20.15 INSTALL SURFACE MOUNTED CONDUITS PARALLEL OR PERPENDICULAR TO BUILDING
- 20.16 WHEREVER POSSIBLE, GROUP CONDUITS ON SUSPENDED OR SURFACE MOUNTED CHANNELS. CONDUITS SHALL NOT BE USED TO SUPPORT OTHER CONDUITS. 20.17 PROVIDE FISH CORD IN EMPTY CONDUITS, MADE OF POLYPROPYLENE.

#### PART 21 - CONDUCTORS

- 21.1 INTERIOR CONDUITS SHALL BE GALVANIZED, ELECTRICAL METALLIC TUBING (EMT) IN ACCORDANCE WITH CSA C22.2 NO.83, COMPLETE WITH FACTORY MADE BENDS FOR CASES WHERE SITE BENDING IS NOT POSSIBLE, JOINTS AND TERMINATIONS MADE WITH SET SCREW TYPE CONNECTORS
- 21.2 FOR SHORT BRANCH CIRCUIT CONNECTORS TO MOTORIZED EQUIPMENT AND/OR TRANSFORMERS (MINIMUM LENGTH OF 18" (450mm), MAXIMUM LENGTH OF 24" (600mm) WITH 180 DEGREE LOOP WHERE POSSIBLE) PROVIDE GALVANIZED STEEL FLEXIBLE FILLID TIGHT METALLIC CONDUIT IN ACCORDANCE WITH CSA C22.2 NO. 56. COMPLETE WITH IDEAL "STEEL TOUGH" LIQUID TIGHT FLEXIBLE CONDUIT CONNECTORS AND TERMINATIONS
- 21.3 FOR EXPOSED EXTERIOR CONDUITS, AND FOR INTERIOR CONDUITS GREATER THAN 2" (50mm) IN DIAMETER AND FOR SURFACE MOUNTED CONDUIT AT HEIGHT LESS THAN 4' (1200mm), PROVIDE RIGID GALVANIZED STEEL IN ACCORDANCE WITH CSA C22.2 NO. 45, COMPLETE WITH FITTINGS. CONNECTORS AND RIGID COUPLINGS 21.4 FOR UNDERGROUND APPLICATIONS, PROVIDE CSA APPROVED, RIGID PVC CONDUIT
- COMPLETE WITH ELBOWS, COUPLINGS, AND EXPANSION JOINTS AND ETC. AS REQUIRED. 21.5 SUPPORT AND SECURE CONDUITS AS SPACING IN COMPLIANCE WITH THE LOCAL STANDARDS BY MEANS OF GALVANIZED PIPE STRAPS, RING BOLT TYPE HANGERS, CONDUIT CLIPS OR BY OTHER CSA APPROVED MANUFACTURED DEVICES.
- 21.6 CONDUIT FITTINGS SHALL BE CONSTRUCTED OF THE SAME MATERIAL AS THE CONDUIT AND SUITABLE FOR THE APPLICATION.

#### 21.7 BEND CONDUITS AT FULL CONDUIT DIAMETER, FREE OF KINKING, FLAKING, OR CRACKING OF FINISHES.

### PART 22 - LIGHTING

- 22.1 THE ELECTRICAL CONTRACTOR SHALL SUPPLY AND INSTALL ALL LUMINAIRES NOTED ON THE DRAWINGS, COMPLETE WITH LAMPS, HANGERS, ACCESSORIES, ETC. FOR A COMPLETE AND OPERATIONAL INSTALLATION.
- 22.2 LUMINAIRES SHALL BE LEFT CLEAN AT COMPLETION OF THE PROJECT WITH ALL LAMPS **OPERATIONAL** 22.3 CLEAN AND RELAMP RELOCATED LUMINAIRES. REPLACE DAMAGED AND/OR BROKEN
- LENSES AND FAULTY BALLASTS. FOR RELOCATED LUMINAIRES, CONFIRM LUMINAIRES ARE FULLY OPERATIONAL 22.4 REFER TO THE LUMINAIRE SCHEDULE FOR EACH TYPE REQUIRED TO MEET THE NEEDS OF

THE PROJECT. ALTERNATES MAY BE CONSIDERED DURING THE TENDER PERIOD.

## PART 23 - PANELBOARDS

- 23.1 PROVIDE EATON CUTLER-HAMMER TYPE "POW R LINE 1" FACTORY ASSEMBLED DEAD FRONT PANELBOARDS.120/208V.3PHASE, 4 WIRE, MANUFACTURED TO CSA STANDARD C22.2 NO. 29 AND OESC, AND DESIGNED FOR AN INTERRUPTING CAPACITY OF 10kA
- SYMMETRICAL AT 208V, UNLESS OTHERWISE NOTED. 23.2 INSTALL PANELBOARDS WHERE REQUIRED, COMPLETE WITH: 1 FEMAC 2 SPRINKLER-PROOF ENCLOSURE CONSTRUCTED OF CODE GAUGE
- GALVANIZED STEEL WITH REMOVABLE BOX ENDS, WIRING GUTTER SPACE ON SIDES, AND WHERE SURFACE MOUNTED; SURFACE MOUNTED TUBS SHALL BE FACTORY FINISHED WITH GREY BAKED ACRYLIC ENAMEL. 2. TRIM FOR RECESSED OR SURFACE WALL MOUNTING AS SHOWN, CONSTRUCTED OF
- CODE GAUGE STEEL; DOORS COMPLETE WITH CONCEALED FASTENERS, CONCEALED HINGE. CHROME PLATED DOOR LATCH AND KEYED ALIKE LOCK WITH KEY. STEEL FRAME HOLDER AND CIRCUIT DIRECTORY BACK OF DOOR, AND MYLAR CIRCUIT BREAKER IDENTIFICATION STRIPS, FACTORY FINISHED WITH GREY BAKED ACRYLIC ENAMEL

### 3. FACTORY PAINTED DRIP SHIELD FOR SURFACE MOUNTED PANELBOARDS

- 4. HARD DRAWN ELECTRICAL GRADE COPPER BUS AND GROUND BUS. HIGH STRENGTH SET SCREW TYPE, ANTI TURNING WIRE CONNECTORS. 6. BOLT ON FULL HEIGHT MODULE CASE CIRCUIT BREAKERS.
- 7. 200% CAPACITY NEUTRALS FOR PANELBOARDS AS SCHEDULED. 8. MAIN BREAKER AND GREEN POWER "ON" INDICATOR LIGHT, WHERE SCHEDULED. 9. INSTALL CIRCUIT BREAKERS IN PANELBOARDS PRIOR TO SHIPMENT. 10. COPPER BUS UNLESS OTHERWISE NOTED. 11. TVSS PROTECTION AS REQUIRED.

- 23.3 PROVIDE DOUBLE LUGGING TO EXISTING PANELBOARDS AS SHOWN AND AS REQUIRED. 23.4 SUPPORT CABINET INDEPENDENT OF CONNECTING CONDUITS, TURN OVER TO CONSULTANT ENGINEER PRIOR TO APPLICATION FOR SUBSTANTIAL PERFORMANCE OR WORK QUANTITY OF TWO (2) PANEL BOARD CABINET KEYS PER PANEL BOARD IDENTIFY
- PANELBOARD BREAKERS IN PERMANENT MANNER, AND COMPLETE TYPED CIRCUIT DIRECORY TO OWNER'S APPROVAL. 23.5 PANELBOARDS TO HAVE THE FOLLOWING MINIMUM INTERRUPTING CAPACITY (kA) OR AS INDICATED ON DRAWINGS OR PANEL SCHEDULES:
- 347/600V PANELBOARDS = 22kA. 23.6 INSTALL SURFACE MOUNTED PANELBOARDS ON FIRE RATED PLYWOOD
- BACKBOARDS OR ON GALVANIZED UNISTRUT STAND-OFFS. 23.7 PANEL BUSSING AND ALL ASSOCIATED CONDUCTORS SHALL BE COPPER 23.8 SHALL BE C/W INSOLATED GROUND AND INSULATED GROUND BUS BAR IN ALL
- 120/208V DISTRIBUTION PANELS. 23.9 ACCEPTABLE MANUFACTURES INCLUDE: SIEMENS ELECTRIC, EATON CUTLER-HAMMER AND AND SQUARE D

#### PART 24 - DEVICES FOR EXISTING PANELBOARDS

120/208V PANELBOARDS = 10kA.

- 24.1 PROVIDE BREAKERS, SWITCH & FUSE ASSEMBLY IN EXISTING PANELBOARDS OF TYPE TO MATCH EXISTING DEVICES. QUALITY AND STANDARD OF DEVICES SHALL MATCH EXISTING. CONFIRM REQUIREMENTS ON SITE PRIOR TO ORDERING
- APPROVED BY THE ENGINEER 24.3 PROVIDE FOR ALL MODIFICATIONS TO PANELBOARDS FOR DEVICES AND FEEDER
- 24.4 REVISE PANEL BOARD DIRECTORY TO REFLECT ADDITIONAL LOADS.

24.2 BREAKERS SHALL BE OF FULL HEIGHT MODULES UNLESS OTHERWISE

#### PART 25 - DRY TYPE TRANSFORMERS

- 25.1 PROVIDE CSA APPROVED STAMPED GALVANIZED STEEL OUTLET BOXES IN ACCORDANCE WITH CSA C22.1. PROVIDE SQUARE OR LARGE OUTLET BOXES AS REQUIRED FOR SPECIAL DEVICES, REFER TO ELECTRICAL DRAWINGS.
- 25.2 GANG BOXES FOR GROUPED WIRING DEVICES 25.3 PROVIDE BLANK COVER PLATES FOR BOXES WITHOUT WIRING DEVICES.
- 25.4 PROVIDE 347V RATED BOXES FOR 347 SWITCHING DEVICES 25.5 PROVIDE PULL BOXES AND JUNCTION BOXES WHERE NECESSARY TO FACILITATE CONDUCTOR/CONDUIT INSTALLATIONS. GENERALLY, PROVIDE CONDUIT RUNS EXCEEDING 100' (30M) IN LENGTH, OR WITH MORE THAN TWO (2) 90-DEGREES BEND
- WITH PULLBOX INSTALLED AT CONVENIENT AND ACCESSIBLE LOCATIONS. 25.6 PROVIDE ELECTRO-GALVANIZED STEEL SINGLE AND MULTI-GANG FLUSH DEVICE BOXES FOR FLUSH INSTALLATION, MINIMUM SIZE OF 75mm X 50mm x 38mm (3"x2"x1-1/2") OR AS INDICATED. PROVIDE 100mm (4") SQUARE OUTLET BOXES WHEN MORE THAN ONE CONDUIT ENTERS ONE SIDE WITH EXTENSION AND PLASTER RINGS AS REQUIRED.
- 25.7 PROVIDE ELECTRO-GALVANIZED STEEL UTILITY BOXES FOR SURFACE MOUNTED BOXES CONNECTED TO SURFACE MOUNTED EMT CONDUITS, MINIMUM SIZE OF 100mm X 54mm X 48mm (4"x2-1/8"x1-7/8").
- 25.8 PROVIDE SQUARE OR OCTAGONAL OUTLET BOXES FOR LIGHTING FIXTURE OUTI FTS 25.9 PROVIDE CONCRETE TIGHT ELECTRO-GALVANIZED SHEET STEEL FLOOR BOX WITH ADJUSTABLE FINISHING RINGS WITH BRUSHED ALUMINUM FACEPLATE TO SUIT THE
- COMMUNICATION EQUIPMENT A MINIMUM DEPT OF 73mm (2-7/8"). 25.10 FOR NON-METALLIC SHEATHED CABLES, PROVIDE ELECTRO-GALVANIZED SECTIONAL SCREW GANGING STEEL BOXES OF MINIMUM SIZE 75mm X 50mm X 63.5mm (3"x2"x2-1/2") COMPLETE WITH TWO (2) DOUBLE CLAMPS.

FLOOR FINISH. FOR RECEPTACLES MINIMUM DEPT OF 28mm (1-1/8"),AND FOR

25.11 BOXES MUST BE ACCESSIBLE AFTER WORK IS COMPLETED. WHERE REQUIRED, SUPPLY ACCESS DOORS OF MINIMUM NO.12 GAUGE PRIME COATED STEEL WITH HINGES AND FRAME TO PROVIDE ACCESS TO BOXES AND CONDUCTOR JOINTS AND OTHER SIMILAR ELECTRICAL WORK WHICH MAY NEED MAINTENANCE OR REPAIR.

#### 25.12 PROVIDE FITTINGS WITH BUSHINGS AND NYLON INSULATED THROAT CONNECTORS WITH KNOCK-OUT FILLERS FOR PREVENTING ENTRY OF DEBRIS. AND WITH DOUBLE LOCKNUTS AND INSULATED BUSHINGS ON SHEET METAL BOXES. 25.13 TRANSFORMER WINDINGS AND ALL ASSOCIATED CONDUCTORS SHALL BE

# PART 26 - FASTENING AND SECURING HARDWARE

CONFIRM FINISHES WITH THE OWNER.

26.1 PROVIDE PROPER FASTENERS AND SIMILAR HARDWARE REQUIRED FOR CONDUITS CONDUCTORS AND FOR FOUIPMENT HANGER AND/OR SUPPORT MATERIAL UNI ESS OTHERWISE NOTED EXPLOSIVE POWDER ACTUATED. FASTENERS WILL NOT BE PERMITTED UNLESS SPECIFIC WRITTEN APPROVAL FOR THEIR USE AND TYPE HAS BEEN OBTAINED FROM THE CONSULTANT UNDER NO CIRCUMSTANCES USE CEILING SUSPENSION HANGERS OR GRIDS FOR SUSPENSION OF CONDUITS AND/OR CONDUITS

# PART 27 - GROUNDING AND BONDING

AND/OR CONDUCTORS.

- 27.1 SUPPLY AND INSTALL COMPLETE GROUNDING AND BONDING SYSTEM AS INDICATED AND AS REQUIRED BY THE CURRENT EDITION OF THE CANADIAN ELECTRICAL CODE AND ELECTRICAL INSPECTION DEPARTMENT. ALL COMPONENTS SHALL BE SECURELY AND ADEQUATELY GROUNDED AND WHERE REQUIRED TO ACCOMPLISH THIS, GROUNDING JUMPERS, GROUNDING STUDS AND BUSHINGS SHALL BE USED. ENSURE THAT ALL RACEWAYS, TERMINAL PANELS, ETC. FOR TELEPHONE LOW VOLTAGE FIRE ALARM SOUND FTC ARE SECURELY AND
- ADEQUATELY GROUNDED AND PROVIDE GROUNDING CONDUCTOR TO WATER MAIN WHERE CALLED FOR OR WHERE REQUIRED. 27.2 ISOLATED GROUND SYSTEM SHALL BE CONTINUOUS THROUGHOUT DISTRIBUTION
- SYSTEMS FROM POINT OF SUPPLY TO POINT OF UTILIZATION. 27.3 ALL I.G RECEPTACLES I.E CASH REGISTERS, MONITORS AND OFFICE I.G SHALL BE ON DEDICATED I.G CIRCUITS. 27.4 THE ISOLATED GROUND WIRE IS TO BE RUN FROM THE RECEPTACLE TO THE PANELBOARD AND CONNECTED TO THE INSULATED/ISOLATED GROUND BUS IN PANEL.

DO NOT CONNECT TO COMMON GROUND BUS IN PANEL.

- PART 28 ELECTRICAL CONNECTIONS FOR MECHANICAL, OWNER'S, ETC., EQUIPMENT 28.1 PROVIDE REQUIRED ELECTRICAL CONNECTIONS TO EQUIPMENT SUPPLIED BY THE MECHANICAL DIVISION, OWNER AND AS PART OF OTHER DIVISIONS. MECHANICAL
- 28.2 ELECTRICAL CONTRACTOR SHALL BE RESPONSIBLE FOR:
- 1. COMPLETE INSTALLATION AND CONNECTION OF STARTERS AND PROVIDE "LINE" AND "LOAD" POWER CONNECTIONS AND INTERLOCKING AS REQUIRED. 2. PROVIDE MOTOR STARTER PANEL CONSISTING OF NO.14 GAUGE STEEL BOLTED PANELS

CONTRACTOR SHALL SUPPLY STARTERS FOR MOTORIZED EQUIPMENT.

SIZED TO ACCOMMODATE STARTERS AND SUITABLE SPLITTER.

- 3. UNLESS OTHERWISE NOTED OR SHOWN ON DRAWINGS, MOUNT 1 PHASE STARTERS ADJACENT TO EQUIPMENT THEY SERVE AND CONNECT COMPLETE. 4. COORDINATE FEEDER ENTRIES TO STARTERS AND STARTER ASSEMBLIES WITH MECHANICAL DIVISION.
- 5. PROVIDE ADDITIONAL DISCONNECT SWITCHES (COMPLETE WITH IDENTIFICATION) DETAILED ON DRAWINGS, REQUIRED BY CODE, OR FOR EQUIPMENT WHICH CANNOT BE SEEN FROM ITS STARTER OR IS IN ACCESS OF 30' (9M) FROM THE

# PART 29 - DISCONNECT SWITCHES

- 29.1 PROVIDE EATON CUTLER-HAMMER, FUSIBLE (COMPLETE WITH FUSE CLIPS) OR NON-FUSIBLE, HEAVY DUTY, CSA APPROVED, FRONT OPERATED TYPE
- DISCONNECT SWITCHES, UNLESS OTHERWISE NOTED ON DRAWINGS 29.2 ENCLOSURE TO BE TYPE NEMA 3R SPRINKLER PROOF, AMP RATING, NUMBER OF POLES AND FUSE REQUIREMENTS AS INDICATED ON DRAWINGS.
- 29.3 INCLUDE PROVISION FOR PADLOCKING IN ON-OFF SWITCH POSITION BY THREE LOCKS. 29.4 MECHANICALLY INTERLOCKED DOOR TO PREVENT OPENING OF DOOR WHEN HANDLE IN
- 29.5 FUSE TYPE TO BE CLASS J, CURRENT LIMITING, SIZE AS INDICATED ON DRAWINGS 29.6 FUSE HOLDER TO BE WITHOUT ADAPTORS. 29.7 ALL FUSIBLE DISCONNECTS TO BE OF QUICK-MAKE AND QUICK-BREAK TYPE.

29.9 PROVIDE EQUIPMENT IDENTIFICATION AND LOAD CONTROLLED NAMEPLATE.

29.10 ACCEPTABLE MANUFACTURES INCLUDE; SIEMENS ELECTRIC AND SQUIRE D.

29.8 PROVIDE ON-OFF SWITCH POSITION ON SWITCH ENCLOSURE.

# PART 30 - FUSES

ON POSITION

- 30.1 PROVIDE EATON CUTLER-HAMMER, FUSIBLE (COMPLETE WITH FUSE CLIPS) OR NON-FUSIBLE HEAVY DUTY CSA APPROVED FRONT OPERATED TYPE DISCONNECT SWITCHES, UNLESS OTHERWISE NOTED ON DRAWINGS 30.2 ENCLOSURE TO BE TYPE NEMA 3R SPRINKLER PROOF, AMP RATING, NUMBER OF POLES
- AND FUSE REQUIREMENTS AS INDICATED ON DRAWINGS 30.3 INCLUDE PROVISION FOR PADLOCKING IN ON-OFF SWITCH POSITION BY THREE LOCKS. 30.4 MECHANICALLY INTERLOCKED DOOR TO PREVENT OPENING OF DOOR WHEN HANDLE

- 30.5 FUSE TYPE TO BE CLASS J, CURRENT LIMITING, SIZE AS INDICATED ON
- 30.6 FUSE HOLDER TO BE WITHOUT ADAPTORS.
- 30.7 ALL FUSIBLE DISCONNECTS TO BE OF QUICK-MAKE AND QUICK-BREAK TYPE. 30.8 PROVIDE ON-OFF SWITCH POSITION ON SWITCH FNCLOSURE
- 30.9 PROVIDE EQUIPMENT IDENTIFICATION AND LOAD CONTROLLED NAMEPLATE. 30.10 ALL FUSES MOTOR LOADS SHALL BE TIME-DELAY TYPE. 30.11 ACCEPTABLE MANUFACTURES INCLUDE; SIEMENS ELECTRIC, COOPER-BUSMAN AND SQUIRE D

#### PART 31 - SPLITTERS TROUGHS

- 31.1 PROVIDE CSA APPROVED SPLITTER TROUGH AS SHOWN ON DRAWINGS. COMPLETE WITH FORMED PRIMED PANTED STEEL BOX WITH KNOCKOUTS, TERMINAL BLOCKS COMPLETE WITH PRESSURE TYPE LUGS, HINGED FRONT COVERPLATE, SUITABLE MOUNTING PROVISIONS AND ALUMINUM IDENTIFICATION
- NAMEDI ATE 31.2 PROVIDE CSA TYPE1 ENCLOSURES IN NON-SPRINKLERED ENVIRONMENT, AND
- CSA TYPE 4/12 IN SPRINKLERED ENVIRONMENTS 31.3 MAIN AND BRANCH LUGS TO MATCH REQUIRED SIZE AND NUMBER OF
- INCOMING AND OUTGOING CONDUCTORS AS INDICATED. 31.4 PROVIDE AT LEAST THREE TERMINALS ON EACH SET OF LUGS FOR SPLITTERS LESS THAN 400A.
- 31.5 SECURE SPLITTER IN PLACE ON PLYWOOD BACKBOARD, INDEPENDENT OF CONNECTING CONDUIT 31.6 ACCEPTABLE MANUFACTURES INCLUDE; SIEMENS ELECTRIC, HAMMOND AND

### PART 32 - SEISMIC PROTECTION

- 32.1 THE ELECTRICAL CONTRACTOR SHALL PROVIDE SEISMIC RESTRAINT AND ANCHORAGE FOR ALL ELECTRICAL EQUIPMENT AND SERVICES IN ACCORDANCE WITH THE CURRENT EDITION OF THE NATIONAL BUILDING CODE AND
- ALL APPLICABLE BUILDING BYLAWS 32.2 INCLUDE IN THE TENDERED PRICE ALL SERVICES OF A REGISTERED PROFESSIONAL IN THE FIELD OF SEISMIC RESTRAINT TO PROVIDE SUPPLEMENTAL SCHEDULE S LETTERS OF ASSURANCE IN RESPECT OF THE SEISMIC RESTRAINT OF ALL ELECTRICAL MATERIALS AND EQUIPMENT. CONDUCTING THE NECESSARY SITE REVIEWS AND PROVIDING A LETTER AT THE CONCLUSION OF THE PROJECT CONFIRMING THAT ALL SEISMIC RESTRAINTS FOR THE ELECTRICAL WORKS HAVE BEEN INSTALLED IN ACCORDANCE WITH THE FNGINFFR'S INSTRUCTIONS SUPPLEMENTAL SCHEDULES TO BE SUBMITTED TO THE ELECTRICAL ENGINEER OF RECORD.

#### PART 33 - FIELD REVIEWS

- 33.1 THE ELECTRICAL CONTRACTOR IS RESPONSIBLE FOR CALLING THE ENGINEER, AS REQUIRED BY THE LOCAL BUILDING CODE, FOR FIELD REVIEWS AT ROUGH-IN, SUBSTANTIAL COMPLETION AND THE COMPLETION
- 33.2 THE ELECTRICAL CONTRACTOR MUST GIVE THE ENGINEER TWO BUSINESS DAYS' NOTICE FOR ALL REVIEWS. 33.3 FAILURE TO INFORM THE ENGINEER OF PROGRESS MAY RESULT IN THE

REVIEW AND COMPLIANCE (SCHEDULE C-B) TO THE BUILDING AUTHORITY.

ENGINEER BEING UNABLE TO ISSUE AN ASSURANCE OF PROFESSIONAL FIELD

## PART 34 - FIRE ALARM (FA)

FND OF PROJECT

OF ANY DEFICIENCIES

- 34.1 INSTALL FIRE ALARM SYSTEM AND/OR DEVICES IN ACCORDANCE WITH LATEST EDITION OF CAN-CSA AND WITH THE REQUIREMENTS OF THE LOCAL AUTHORITIES HAVING JURISDICTION.
- 34.2 ALL FIRE ALARM SYSTEM ALTERATIONS AND REVERIFICATION SHALL BE BY LANDLORD'S FIRE ALARM CONTRACTOR AT THE TENANTS EXPENSE. BASE BUILDING FIRE ALARM CONTRACTOR TO INSTALL ALL DEVICES AND MAKE FINAL CONNECTIONS TO THE FIRE ALARM CONTROL PANEL (FACP).

34.3 ALL FA WIRING SHALL BE INSTALLED IN CONDUIT IN COMPLIANCE WITH THE

- LOCAL ELECTRICAL SAFETY CODE (I.E. OESC). ALL CONDUITS SHALL HAVE A GROUND WIRE 34.4 ANY FIRE ALARM DEVICES NOT SPECIFICALLY NOTED TO BE DEMOLISHED ON PLANS SHALL REMAIN OPERATIONAL AND BE CLEANER AND REVERIFIED AT THE
- RENOVATIONS AND ADDITIONS SHALL BE CONNECTED TO FIRE ALARM SYSTEM AT DESIGNATED CONNECTION POINT AS DETERMINED ON SITE BY LANDLORD. CONTACT OPERATIONS MANAGER AND COORDINATE ON SITE FINAL CONNECTION WILL BE BY LANDLORD CONTRACTOR AS WELL AS FIRE ALARM VERIFICATION. COST OF THIS WORK WILL BE PAID FOR BY TENANT 34.6 THE MANUFACTURER'S REPRESENTATIVE SHALL MAKE AN INSPECTION OF THE

FIRE ALARM EQUIPMENT INCLUDING THOSE COMPONENTS NECESSARY TO THE

DIRECT OPERATION OF THIS SYSTEM (WHETHER OR NOT MANUFACTURED BY THE

34.5 ALL NEW FIRE DETECTION AND SIGNALING DEVICES ADDED DUE TO

- MANUFACTURER). ON COMPLETION OF THE INSPECTION THE MANUFACTURER SHALL ISSUE TO THE LANDLORD A CERTIFICATE OF VERIFICATION AND A COPY TO THE TENANT. ALL WORK SHALL BE BY LANDLORD AT THE TENANT'S EXPENSE. 34.7 ALL MODIFICATIONS TO FIRE ALARM SYSTEM AND DEVICES TO BE COMPLETED BY THE BASE BUILDING FIRE ALARM CONTRACTOR AND VENDOR/MANUFACTURER. THE BASE BUILDING FIRE ALARM CONTRACTOR/VENDOR/MANUFACTURER IS RESPONSIBLE TO ENSURE THAT ALL ADDITIONAL COMPONENTS (MATERIAL, SOFTWARE, INCLUDING ANY LABOUR TO INSTALL OR MODIFY THE FIRE ALARM DEVICES) ARE INCLUDED FOR BASED ON THE ISSUED DRAWINGS. ELECTRICAL CONTRACTOR TO ALLOW FOR ALL ASSOCIATED COSTS. NEW FIRE ALARM DEVICES (EVAC SPEAKERS AND SPEAKER/STROBE COMBINATIONS) SHALL MATCH EXISTING. THE CONTRACTOR SHALL CONNECT NEW SPEAKERS TO EXISTING SPEAKER CIRCUITS, WHERE THERE IS SPARE CAPACITY ON THE RESPECTIVE CIRCUITS. IF THERE IS NO CAPACITY ON THE EXISTING BELL. SPEAKER/STROBE CIRCUITS. THE CONTRACTOR SHALL
- AND VERIFICATION TO MAKE THE SYSTEM OPERATIONAL AND CODE COMPLIANT. ALL FIRE ALARM VERIFICATION SHALL CONFORM TO CAN/ULC-S537 LATEST EDITION. THE FIRE ALARM SYSTEM SHALL BE INSTALLED IN CONFORMANCE WITH CAN/ULC-S524 LATEST EDITION. 34.8 ANY FIRM ALARM DEVICES THAT HAVE BEEN RELOCATED OR WORKED ON.

SHALL BE TESTED. VERIFIED AND CERTIFIED BY THE MANUFACTURER'S

ALLOW FOR ALL ASSOCIATED COSTS INCLUDING BUT NOT LIMITED TO;

PROVIDE NEW FIRE ALARM CIRCUITS. THE VENDOR WILL RELOCATE AND MODIFY

THE TAPS ON SPEAKERS AS NECESSARY TO ENSURE A COMPLIANCE WITH CODE.

ASSOCIATED EQUIPMENT, AMPLIFIERS, EVAC SPEAKERS, PROGRAMMING, TESTING

AUTHORIZED TECHNICIAN UPON COMPLETION OF WORK. INCLUDE FOR ALL ASSOCIATED COSTS 34.9 ALL WORK ON THE FA SYSTEM SHALL BE PERFORMED BY CERTIFIED FA

# TECHNICIAN

DISTURBANCES.

AND CONDUIT RECEPTACLES.

- PART 35 ACCESS DOORS 35.1 PROVIDE A MINIMUM No.12 GAUGE PRIME COAT PAINTED STEEL FLUSH ACCES DOOR, COMPLETE WITH A HEAVY FRAME AND ANCHOR, HEAVY DUTY RUST RESISTANT CONCEALED HINGES, A POSITIVE LOCKING SCREWDRIVER LOCK AND
- SHALL BE ULC LISTED AND LABELED AND OF A RATING TO MAINTAIN THE FIRE SEPARATION INTEGRITY. 35.3 ACCESS DOORS LOCATED IN SURFACES WHERE SPECIAL FINISHES ARE REQUIRED, SHALL BE OF A RECESSED DOOR TYPE CAPABLE OF ACCEPTING THE FINISHWHICH MAY CAUSE NOSE DISTURBANCES MUST BE SCHEDULED AT TIMES APPROVED BY

THE CONSULTANT. COORDINATE WORK WITH TRADES TO MINIMIZE NOSE

35.2 ACCESS DOORS IN FIRE RATED CEILINGS, WALLS, PARTITIONS, AND STRUCTURES

#### PART 36 - ELECTRICAL INSPECTIONS/ SIGN OFFS REQUIRMENTS CONTRACTOR SHALL PROVIDE THE FOLLOWING FOR OCCUPANCY

- 36.1 UNDERGROUND INSPECTION PRIOR TO BACKFILL ELECTRICAL CONDUITS, MAIN INCOMING SERVICES, AND DATA CONDUITS. 36.2 IN WALL INSPECTION PRIOR TO DRY WALL CLOSE UP - BOX WIRE RECEPTACLES
- 36.3 FINAL INSPECTION LABELED ELECTRICAL RECEPTACLES, LIGHT FIXTURES, EMERGENCY LIGHTING, EXIT SIGNS, AND PANEL DIRECTORIES. 36.4 REQUIRED FOR OCCUPANCY FINAL SIGN OFF LETTER - CERTIFICATE OF FINAL INSPECTION FROM THE LOCAL HYDRO INSPECTING AUTHORITY, EMERGENCY LIGHT REPORT, CONTRACTOR WARRANTY LETTER, CHAIN HUNG LETTER FOR ALL

LIGHTING FIXTURES, FIRE ALARM VERIFICATION, AND SEISMIC SIGN OFF LETTER.

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G.L. SMITH

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# Date

REVISION

# Date

DRAWING TITLE:

PROJECT TITLE	:	
	STEEL	

ISSUED FOR CLIENT REVIEW

Description

KILDONAN CROSSING 1616 REGENT AVE W WINNIPEG, MB

CRU # 4

ELECTRICAL SPECIFICATIONS

Description

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